


- NOTES:**
1. Valves shall have flanged ends. Flanged ends shall conform to ASA B16.1, Class 125 lb.
 2. Rollers, tracks and scrapers for horizontal valves shall conform to AWWA Specification C500 with the following exception: Babbitt tracks will not be acceptable.
 3. All valves 18" and larger shall be designed for horizontal pipe line unless otherwise called for. All other valves are to be vertical.
 4. For cast in place or precast manholes, see sanitary sewer manholes for materials.


PLAN

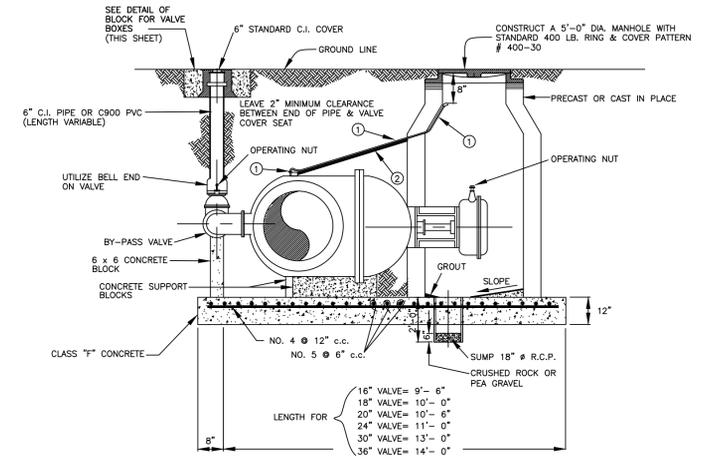

- ① = CORP. COCK & 3/4" COPPER PIPE UNLESS OTHERWISE SPECIFIED
- ② = 2 x 4 BOARD FOR SUPPORT


SECTION A-A

HORIZONTAL VALVE INSTALLATION

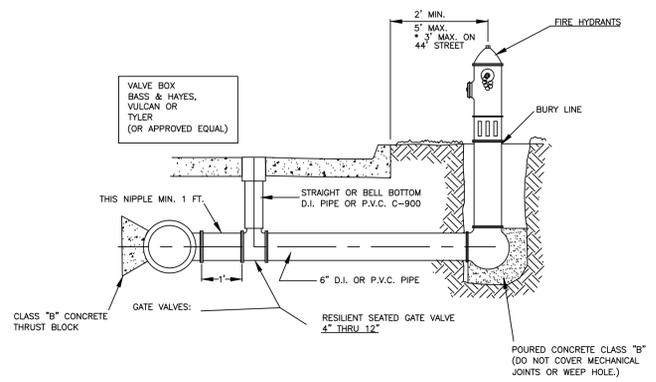


- NOTES:**
1. ALL FITTINGS ARE MECHANICAL JOINTS, EXCEPT VALVE TO TEES OR WYES MAY BE FLANGE TO FLANGE.
 2. PLACEMENT OF FIRE HYDRANTS IN SIDEWALK IS PROHIBITED.
 3. PEA GRAVEL TO BE PLACED AROUND WEEP HOLE.
 4. HYDROLOCK IS NOT REQUIRED.

FIRE HYDRANT ASSEMBLY

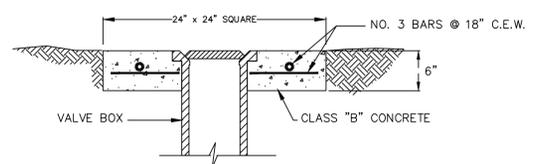


DETAIL OF BLOCK FOR VALVE BOXES


NOT IN PAVEMENT

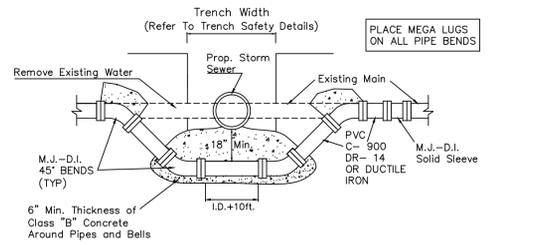

WATER MAIN LOWERING

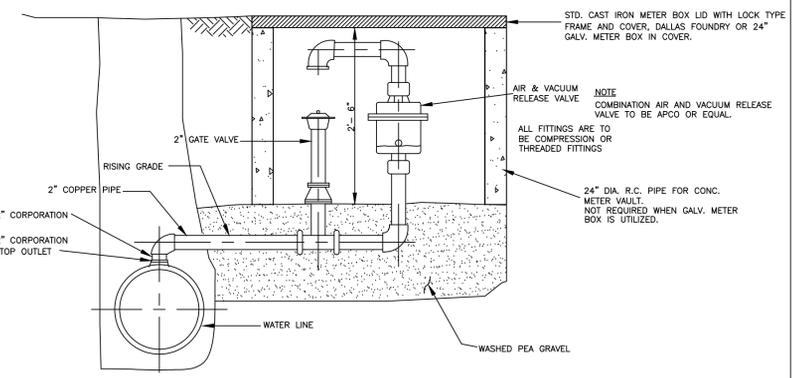

AIR RELEASE VALVE

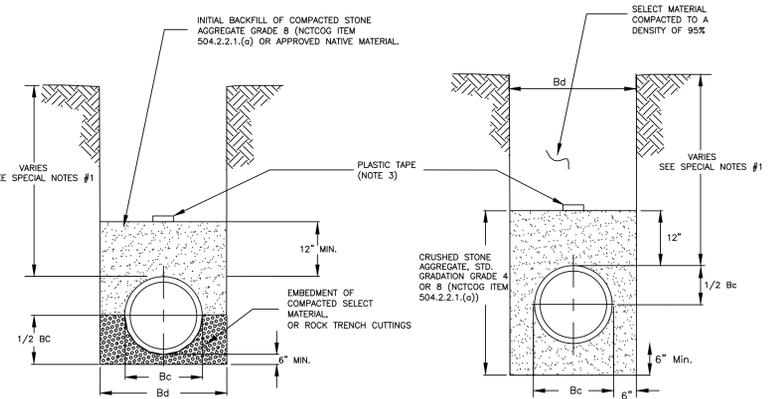

DUCTILE P.V.C. C-900 (CLASS 200)

FOR RCP SEE MANUFACTURER'S LAYING SCHEDULE FOR EMBEDMENT DETAIL.

EMBEDMENT FOR WATER CONDUITS

ACCEPTED MATERIALS MANUFACTURERS (SEE NOTE 9)

- GATE VALVES**
M & H
CLOW
- RESILIENT SEATED GATE VALVE**
4" THRU 12"
MUELLER
CLOW
KENNEDY
AFC
AVK
- TAPPING SLEEVES**
M & H
CLOW
MUELLER
AFC
TYLER
- TAPPING VALVES**
M & H
CLOW
MUELLER
AFC
AVK

- FIRE HYDRANTS**
MUELLER #A423
M & H #129
CLOW #F2545
KENNEDY 5-1/4" K81D
AVK #2700
WATEROUS #WB-67

- ADJUSTABLE VALVE BOX WITH LID**
TYLER
BASS & HAYES
EAST JORDAN IRON WORKS

- VALVE BOX WITH LID**
FOR USE WITH C-900 P.V.C. VALVE STACK
EAST JORDAN IRON WORKS
TYLER
BASS & HAYES

- STAINLESS STEEL WATERMAIN REPAIR CLAMP WITH OR WITHOUT SERVICE OUTLET**
MUELLER
FORD

- APPROVED PIPE**
4-12" C-900-DR 14
GREATER THAN OR EQUAL TO 14" C-905-DR 18
CLASS 200, DR 14
DUCTILE IRON: CLASS 50 & 51 WITH MECHANICAL JOINT ACCESSORIES CEMENT LINED.

- APPROVED FITTINGS**
MADE IN USA ONLY


- COMBINATION AIR VALVES**
STANDARD, SINGLE- BODY DOUBLE ORIFICE
1" THRU 6"; APCO OR APPROVED EQUAL

- GATE VALVES FOR COMBINATION AIR VALVES**
1" THRU 2"
NIBCO # T- 131; # T- 133, OR APPROVED EQUAL


ALL MATERIALS AND WORKMANSHIP TO CONFORM TO THE REQUIREMENTS SET FORTH IN THE LATEST EDITION OF THE CITY OF RICHARDSON'S MANUAL FOR GENERAL PROCEDURES FOR THE DESIGN OF WATER AND SEWER LINES AND WATER DEPARTMENT STANDARDS.

SPECIAL NOTES:


1. WATER MAINS SHALL HAVE THE FOLLOWING MINIMUM COVER BELOW STREET GRADES: 6", 3.5', 8", 4.0', 12", 5.0': LARGER, AS SHOWN ON PLANS.
2. ALL RESIDENTIAL WATER SERVICES SHALL BE 1" MINIMUM.
3. PLASTIC TAPE FOR SERVICES TO BE ATTACHED TO THE ENDS OF ALL SERVICE LINES AND EXTEND ABOVE GROUND LEVEL. THE TAPE SHALL MEET THE FOLLOWING SPECIFICATIONS:
 - a. "ALLEN MARKING TAPE" OR EQUAL.
 - b. ROLL MARKED CONTINUOUSLY, "CAUTION SEWER LINE", OR "CAUTION WATER LINE".
 - c. SIX (6) INCHES IN WIDTH.
 - d. GREEN TAPE FOR SEWER SERVICES, BLUE TAPE FOR WATER SERVICE.
4. LOCATE WATER SERVICES 10 FT. UPSTREAM OF SANITARY SEWER SERVICES.
5. ALL STUBOUTS SHALL BE ONE FULL JOINT OF PIPE.
6. REMOVE BLEEDER AND PLUG WITH BRASS PLUG.
7. CONTRACTOR SHALL MEET (TOEQ) STANDARDS FOR SEPARATION OF WATER AND SEWER CONDUITS.
8. CONTRACTOR SHALL SUPPLY ALL EQUIPMENT, LABOR, MATERIALS, AND ANY OTHER APPURTENANCES NECESSARY TO TEST WATER AND SEWER LINES TO CITY STANDARDS.
9. APPROVED MATERIALS LIST IS AVAILABLE FROM THE UTILITY SYSTEMS MANAGER ENGINEER AT THE CITY OF RICHARDSON SERVICE CENTER 1260 COLUMBIA DRIVE, RICHARDSON, TEXAS. TELEPHONE 972-744-4411.

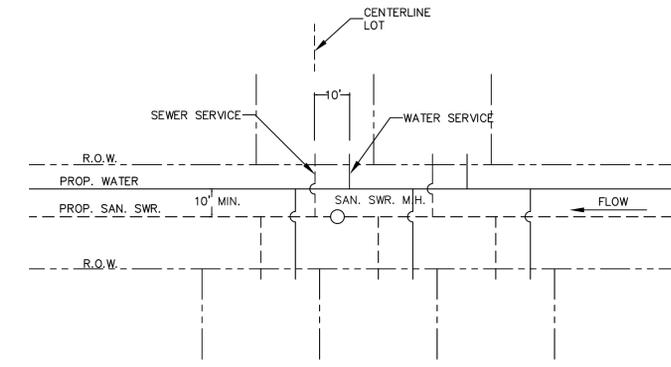

TYPICAL LOT SERVICE DETAIL

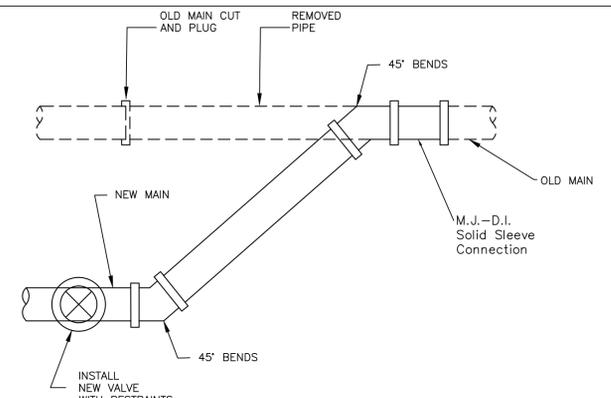

WATER MAIN CONNECTION DETAIL

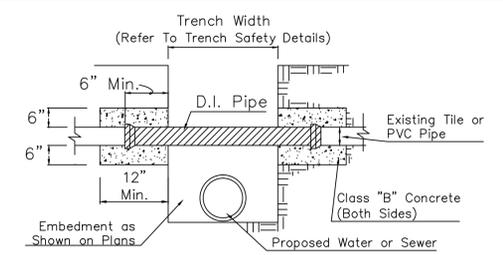

UTILITY SUPPORT DETAIL

Revisions:

City of Richardson
411 W. Arapaho Road
Suite 204
Richardson, Texas 75080
voice: 972 744-4280
fax: 972 744-5804

Drawn By: RGB
Checked By: COR



STANDARD DETAILS
City of Richardson, Texas

NO ADDITIONS OR CHANGES TO STANDARD DETAIL SHEETS UNLESS APPROVED BY CITY OF RICHARDSON

24"x36" Scale: NTS

11"x17" Scale: NTS

Vertical Scale: NA

Project Number: XXX

Issue Date: 01 MAY 14

Sheet Title:

WATER

Sheet No.:

C-1

Revisions:

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Suite 204
Richardson, Texas 75080
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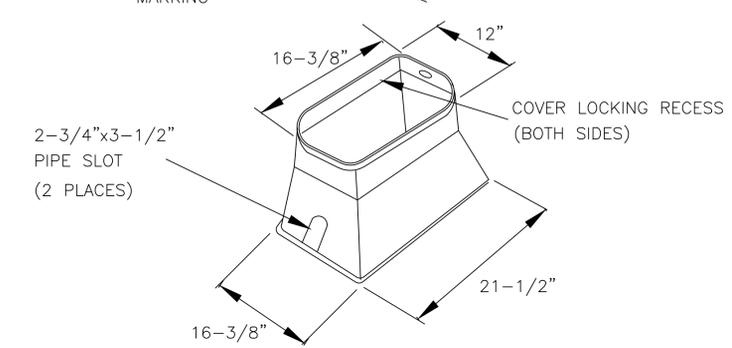
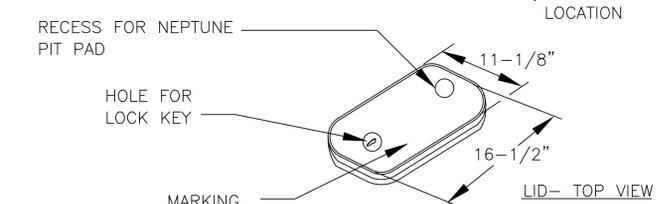
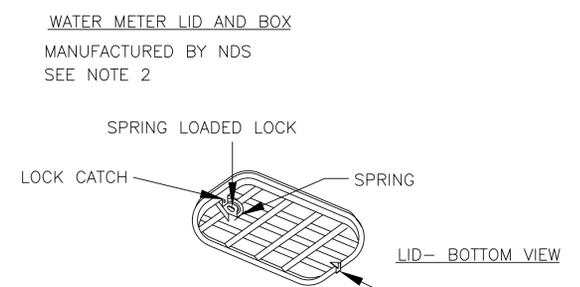
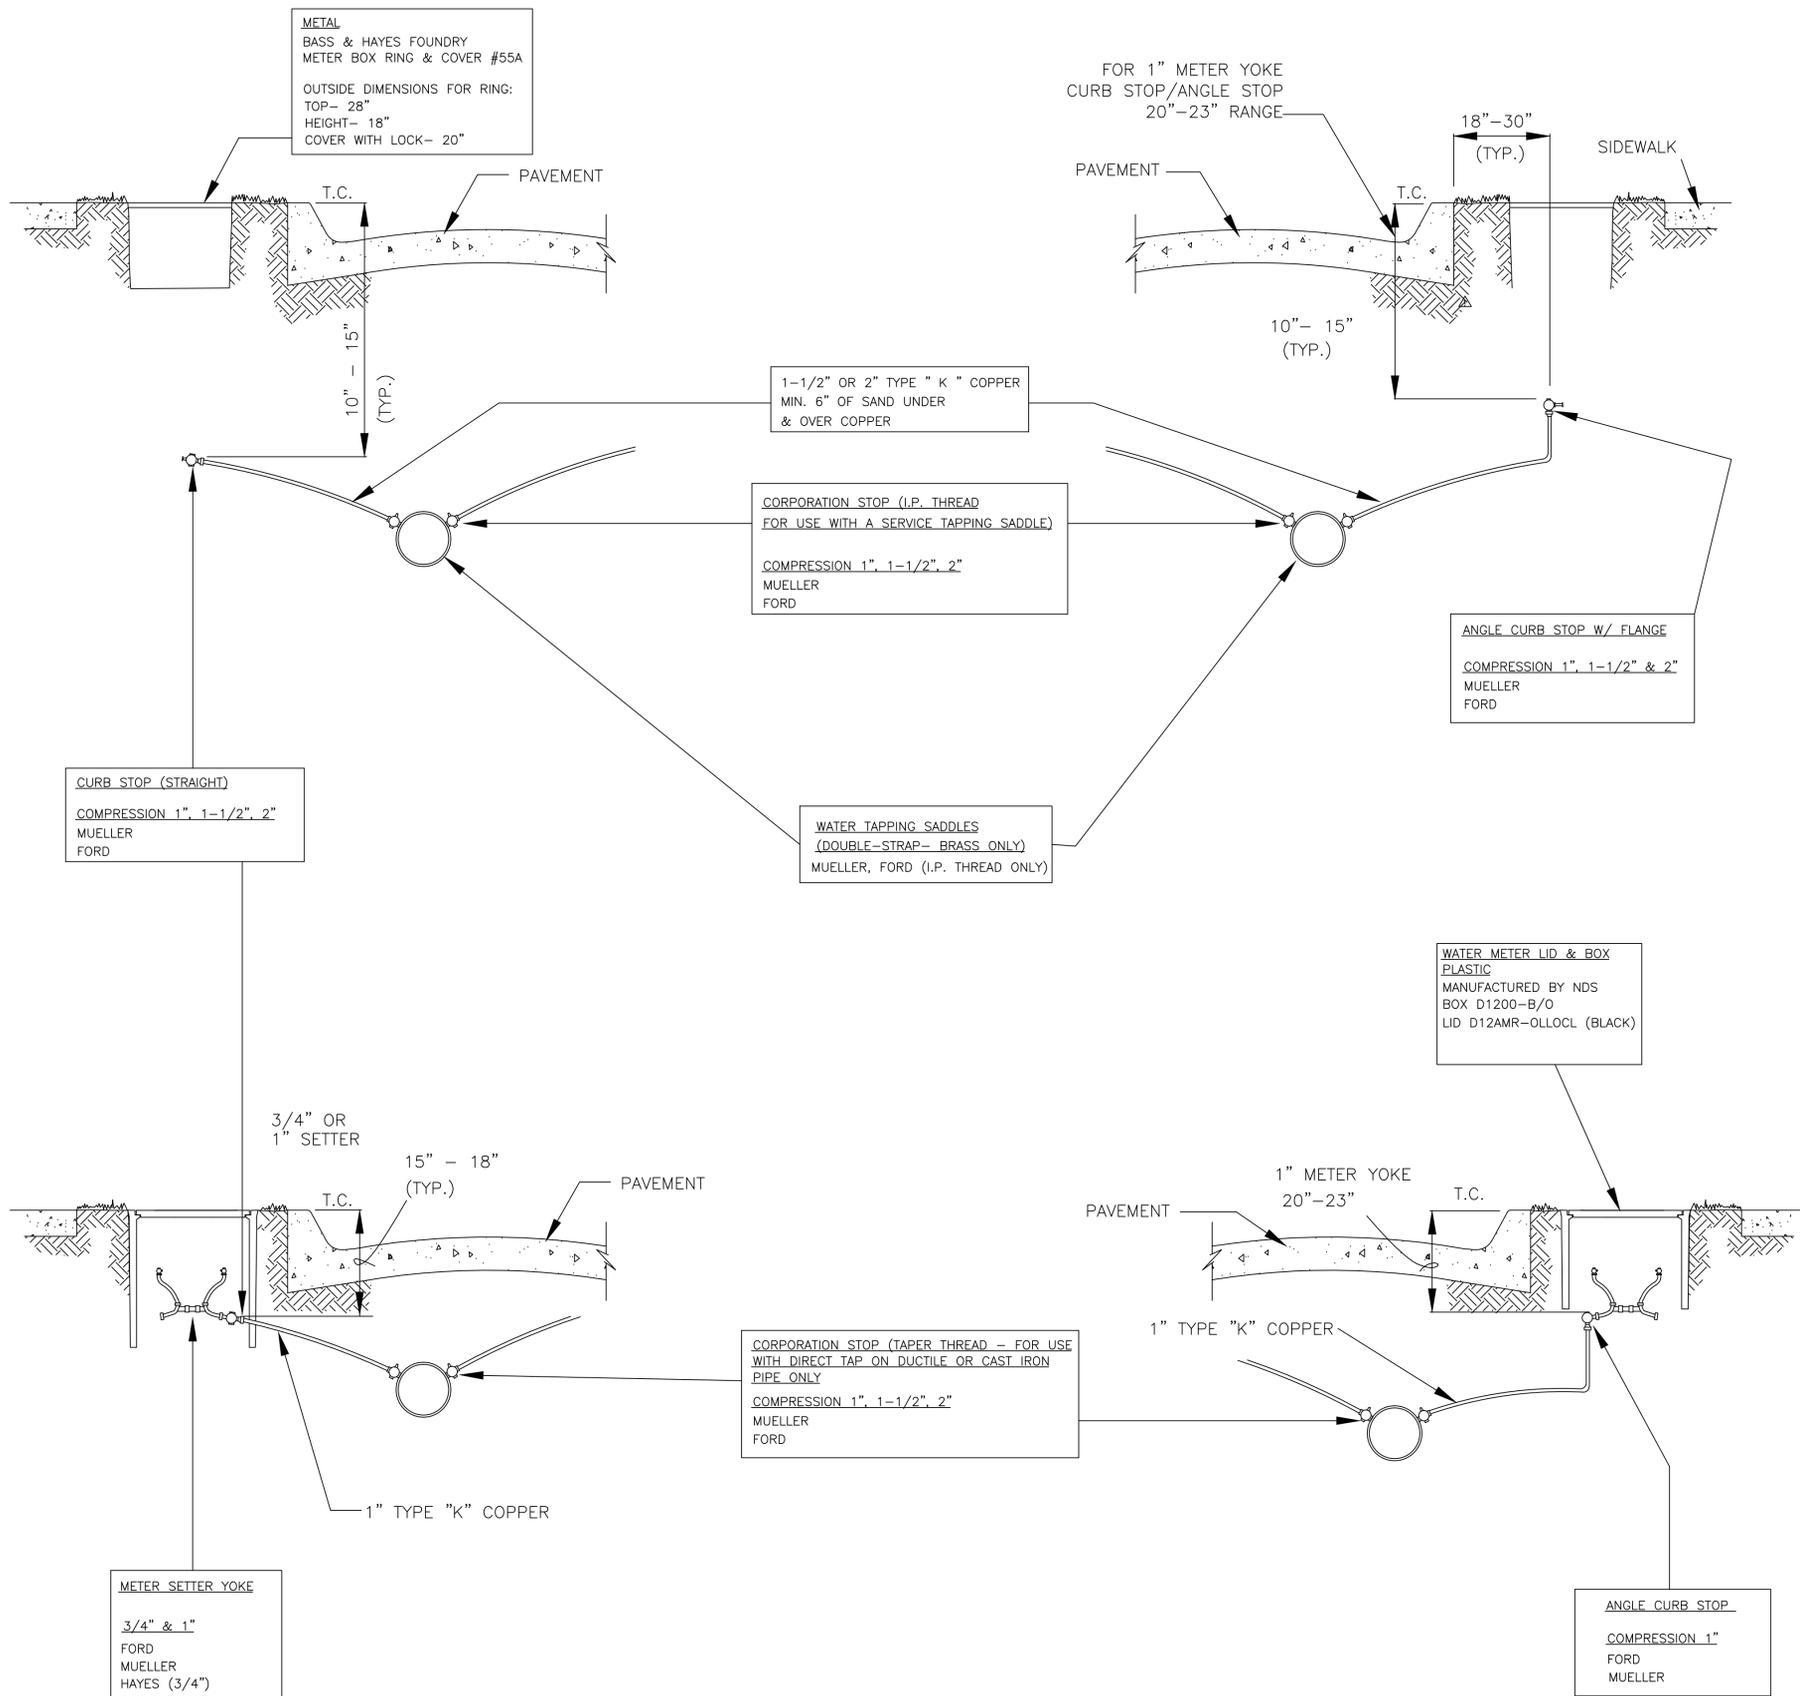
Issue Date: 01 MAY 14

Sheet Title:

WATER SERVICE

Sheet No.:

C-2




MISCELLANEOUS METER FITTINGS
(PROVIDED BY CONTRACTOR)

3/4" METER INSTALLATIONS:
1" to 3/4" brass pipe thread reducer, any brand.
3/4" x 3" brass nipple, any brand.
For 1" angle stops: 1- 1/4" x 3/4" water meter bushings.
Acceptable Brands: Ford or approved equal brand, see Note 2.
One plastic Water Meter Box and lid, NDS brand, see Note 2.

1" METER INSTALLATIONS:
1" x 3" brass nipple, any brand.
For 1" angle stops: 1- 1/4" x 1" water meter bushings.
Acceptable Brands: Jones, Mueller, and Ford, see Note 2.
One plastic Water Meter Box and lid, NDS brand, see Note 2.


1- 1/2" & 2" METER INSTALLATIONS:
3" long brass nipple, any brand.
2 bolt meter flange: all brass with female pipe thread connections, any brand.
28" x 18" galvanized meter box with utility key lock.
Bass & Hayes #55A

- NOTES:**
- Dimensions shown are approximate.
 - Approved materials list is available from the Water Utility Systems Manager Engineer at the City of Richardson Service Center 1260 Columbia Drive, Richardson, Texas. Telephone 972-744-4411.
 - Flare fittings are not allowed.
 - Center Meter in Parkway between sidewalk and back of curb. Do not place box in sidewalk.

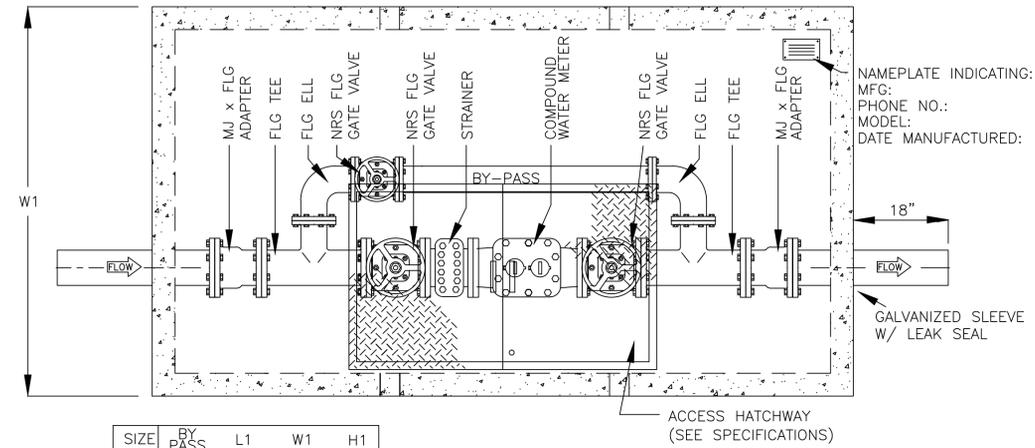

SIZE	BY PASS	L1	W1	H1
4"	2"	8'-8"	4'-8"	4'-6"
6"	4"	11'-0"	6'-0"	4'-6"

PLAN VIEW

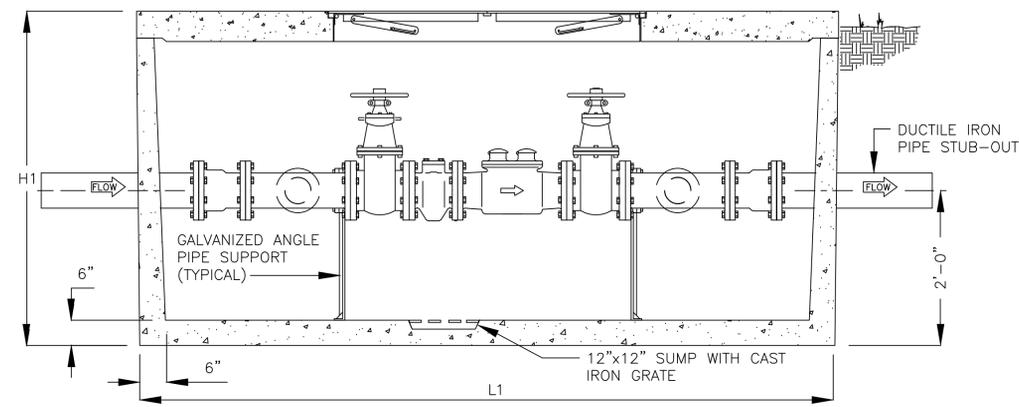




ELEVATION

PIPE AND FITTINGS SHALL BE DUCTILE IRON

- SPECIFICATIONS**
- CONCRETE : CLASS 1 CONCRETE WITH DESIGN STRENGTH OF 4500 PSI AT 28 DAYS. UNIT IS OF MONOLITHIC CONSTRUCTION AT FLOOR AND FIRST STAGE OF WALL WITH SECTIONAL RISER TO REQUIRED DEPTH.
- REINFORCEMENT: GRADE 60 REINFORCED STEEL BAR CONFORMING TO ASTM A615 ON REQUIRED CENTERS OR EQUAL.
- HATCHWAY: 3' X 5' GALVANIZED STEEL DOUBLE LEAF SPRING ASSISTED HATCHWAY - TRAFFIC RATED W/ SLAM LOCK.


1. PRECAST VAULT SHALL BE FROM HANSEN PIPE & PRECAST, GRAND PRAIRIE, TEXAS PLANT OR APPROVED OTHER EQUAL.
2. DIMENSIONS SHOWN ARE APPROXIMATE ONLY.
3. SHOP DRAWINGS SHALL BE SUBMITTED BY CONTRACTOR FOR APPROVAL BY THE ENGINEER AND ACCEPTANCE BY CITY OF RICHARDSON PRIOR TO CONSTRUCTION.

DOMESTIC WATER METER VAULT

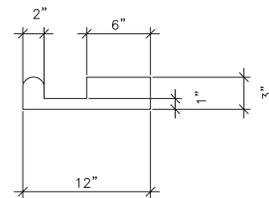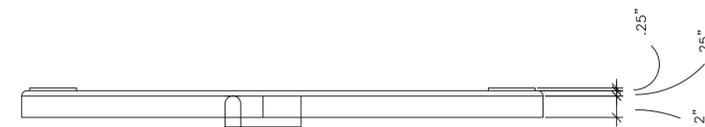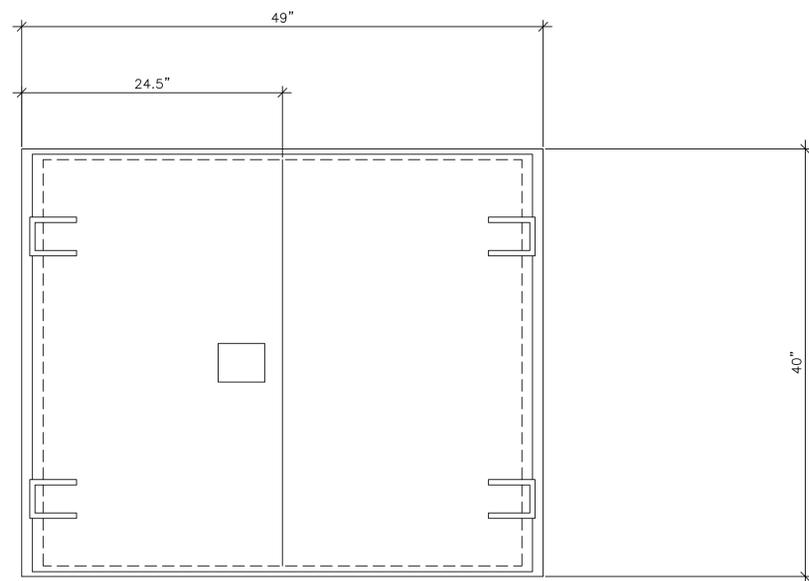



1. NON-STICKING HINGES
2. LOCKING HASP FOR YOUR LOCK
3. FACTORY APPLIED PRIME COAT
4. EASY OPENING HANDLE
5. 1/4" PLATE DOOR

DOUBLE LEAF METAL DOOR

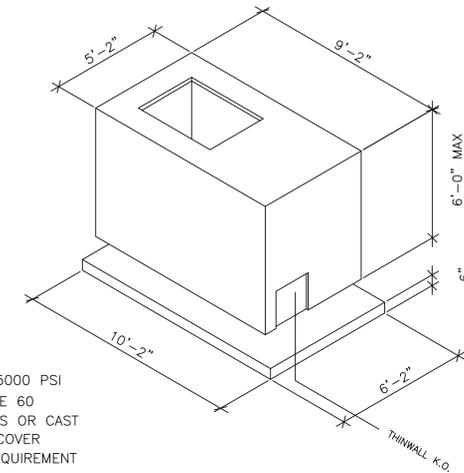

1. CONCRETE: 5000 PSI
2. REINF. GRADE 60
3. METAL DOORS OR CAST IN RING & COVER PER JOB REQUIREMENT
4. FLOOR SLAB OPTIONAL

**HANSEN PIPE & PRECAST
COMPOUND METER VAULT
GRAND PRAIRIE, TEXAS PLANT**

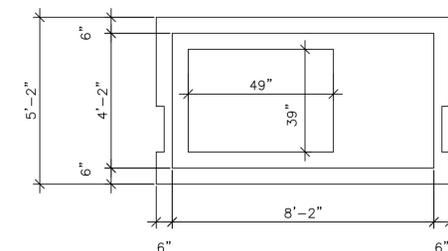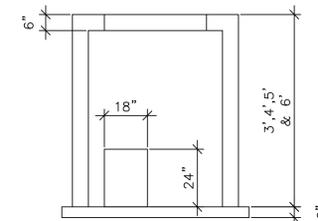

Revisions:

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voice: 972 744-4280
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**STANDARD
DETAILS**
City of Richardson, Texas

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24"x36" Scale: NTS

11"x17" Scale: NTS

Vertical Scale: NA

Project Number: XXX

Issue Date: 01 MAY 14

Sheet Title:


**WATER
VAULT**

Sheet No.:

C-3


INSTALLATION
FALSE MANHOLE BOTTOMS WILL BE FURNISHED AND INSTALLED IN ALL MANHOLES CONSTRUCTED IN ADVANCE OF PAVING. THESE FALSE MANHOLE BOTTOMS WILL BE INSTALLED AT A TIME DIRECTED BY THE ENGINEER, BUT WILL USUALLY BE AFTER ALL WORK IS COMPLETED ON THE SANITARY SEWER SYSTEM INCLUDING THE AIR TEST, BUT PRIOR TO THE FINAL INSPECTION.

REMOVAL
FALSE MANHOLE BOTTOMS WILL BE REMOVED AFTER THE FINAL APPURT. ADJUSTMENT INSPECTION. THE PAVING CONTRACTOR AND CITY FORCES REPRESENTATIVES WILL COORDINATE THE REMOVAL OF THE FALSE MANHOLE BOTTOMS.

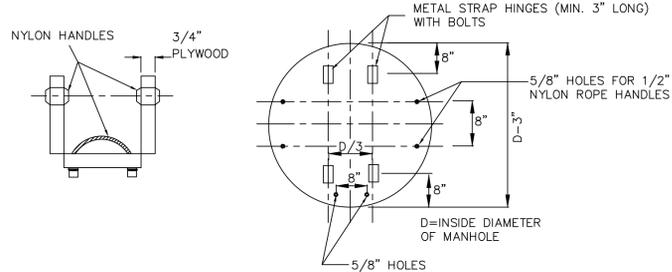

FALSE MANHOLE BOTTOM

NOTES:
1. MANHOLE RISER PIPE FURNISHED IN LENGTHS OF 1,2,3,4 OR 6 FEET.
2. ANY ODD LENGTH JOINT USED AS MANHOLE RISER 1'-0" & 3'-0" SHOULD BE USED AS THE BASE RISER.
3. DROP CONNECTIONS WILL BE REQUIRED WHERE VERTICAL DISTANCE FROM MANHOLE INVERT TO FLOW-LINE OF INCOMING PIPE IS 30" OR GREATER.

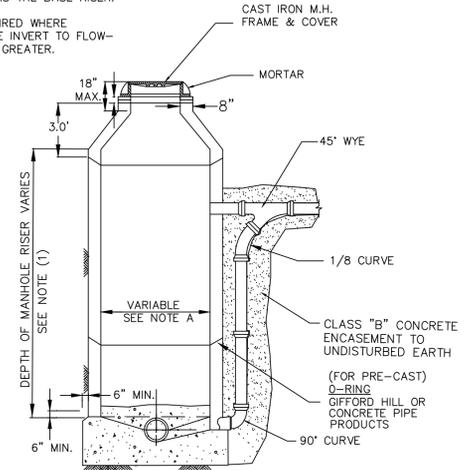

NOTE: (A) MANHOLES FOR 6", 8" & 10" LINES SHALL BE 48" DIA. MANHOLES FOR 12", 15" & 18" LINES SHALL BE 60" DIA. MANHOLES FOR 21", 24" & 27" LINES SHALL BE 72" DIA.

STANDARD MANHOLE WITH DROP CONNECTION

SEWER COLLECTION MATERIALS

STANDARD BOLT DOWN TYPE RING & COVER
(To be used on trunklines, areas of flooring, or as specified)
5/8" stainless hex cap screws
Acceptable Brands:
Boss & Hayes VRM-30 Watertight or approved equal

STANDARD 400 LB RING & LID
(To be used at all times)
Pattern #400-30D
Acceptable Brands:
Boss & Hayes VRM-30 or approved equal

STANDARD 400 LB RING EXTENSION
Pattern #400-30
3" Rise Only
Acceptable Brands:
Boss & Hayes



MANHOLE PIPE CONNECTOR
Designed to meet the resilient connectors requirements of ASTM C-923
Acceptable Brands:
Vulcan or Equal Tyler

STANDARD SANITARY SEWER FIELD CLEANOUT
Pattern #339
Acceptable Brands:
Vulcan or Equal Tyler

MANHOLE PIPE CONNECTORS
GPK Manhole Couplings
Ultra-Rib Manhole Sleeve Coupling
CEMENT COUPLING WITH O-RING RUBBER GASKET FOR PIPE OTHER THAN CLAY OR CONC. ALT. COUPLINGS MUST BE APPROVED BY CONSTR. ENGR.


NOTES:

- All materials and workmanship to conform to the requirements set forth in the latest edition of the City of Richardson's MANUAL FOR GENERAL PROCEDURES FOR THE DESIGN OF WATER & SEWER LINES and Water Department Standards.
- In the event an item is not covered by this manual, then the latest edition of the "Standard Specifications for Public Works Construction - North Central Texas" as adopted by the North Central Texas Council of Governments covering such items shall apply.
- Forms for cast in place manholes shall remain in place, undisturbed, for a minimum of 24 hours.
- Gravity Pipe for Sewer Applications
4"-15" SDR-35 (Gravity)
4"-12" AWWA C-900-07-DR14 Green
Greater than or equal to 14" AWWA C-905-10-DR18 Green
- All residential sewer services shall be 4" Minimum.
- Locate sanitary sewer services in middle of lots, 4' past R.O.W. line (See Sheet C-1). - MAXIMUM 4' Deep.
- All stubouts shall be one (1) full joint of pipe, and/or 3' past any pavement.
- Plastic tape for services to be attached to the ends of all service lines and extend above ground level. The tape shall meet the following specifications:
A. "Alien Marking Tape" or equal.
B. Roll marked continuously, "Caution Water Line" or "Caution Sewer Line"
C. Six (6) inches in width.
D. Green tape for sewer services, blue tape for water services.
- Free fall of concrete not to exceed 5 ft. MAX.
- Contractor shall meet TCEQ standards for separation of water and sewer conduits where applicable.

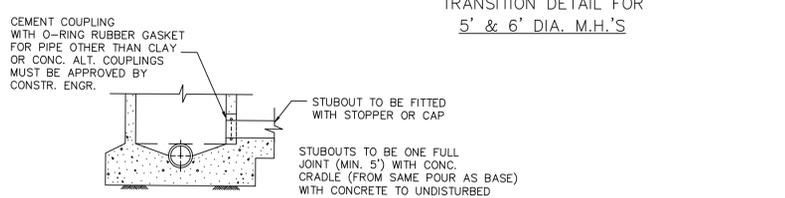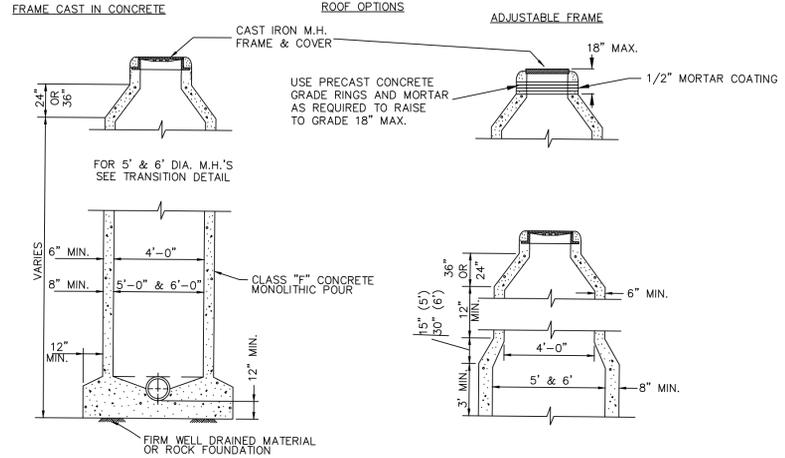


CAST IN PLACE MANHOLE

(PRECAST CONCRETE MANHOLES SHALL COMPLY WITH N.C.T.C.O.G. SPECS. STANDARD DRAWING NO. 5020)

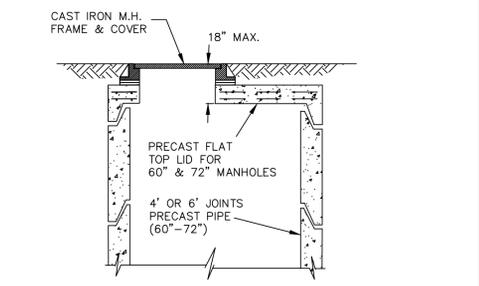


ALTERNATES FOR SANITARY SEWER MANHOLES
MANHOLES FOR SANITARY SEWERS SHALL BE CONSTRUCTED OF EITHER PRECAST REINFORCED CONCRETE PIPE MANHOLE SECTIONS.

ALTERNATE COVER FOR MANHOLE

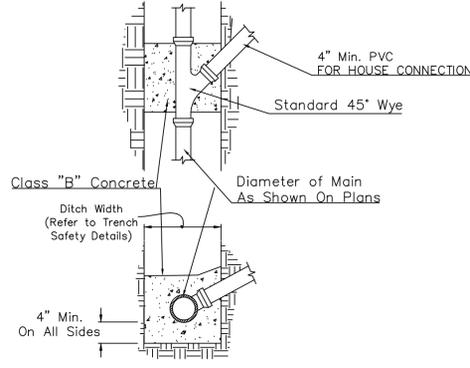


STANDARD SERVICE CONNECTION

NOTE:
Wyes To Be Encased Within Limits Of Ditch Lateral Encasement Shall Be Provided When Existing Field Conditions Warrant. Ties to Existing Mains Shall Utilize "Y" or "T" Saddles.

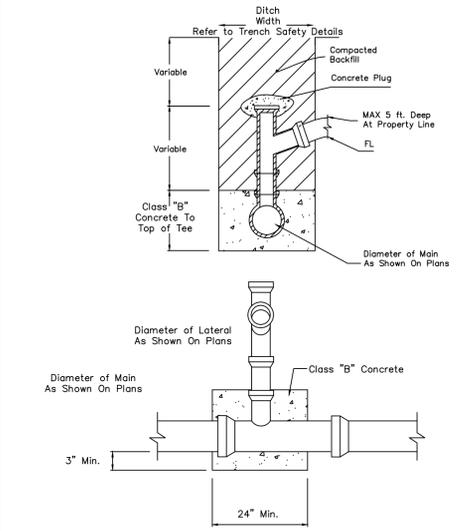


DROP CONNECTION

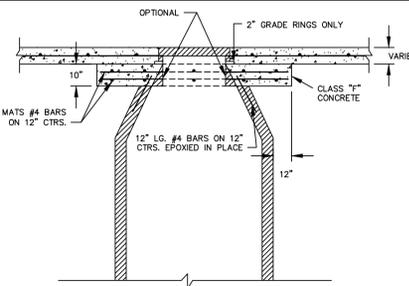


**MANHOLE HEIGHT ADJUSTMENT
DETAIL FOR EXISTING BRICK
MANHOLE OR POURED IN PLACE**


* VARIES IF CLEANOUT IS IN CONCRETE

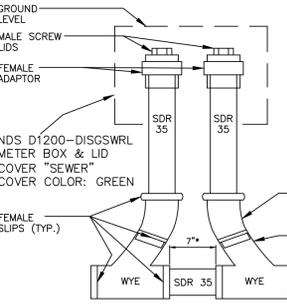

DOUBLE CLEANOUT

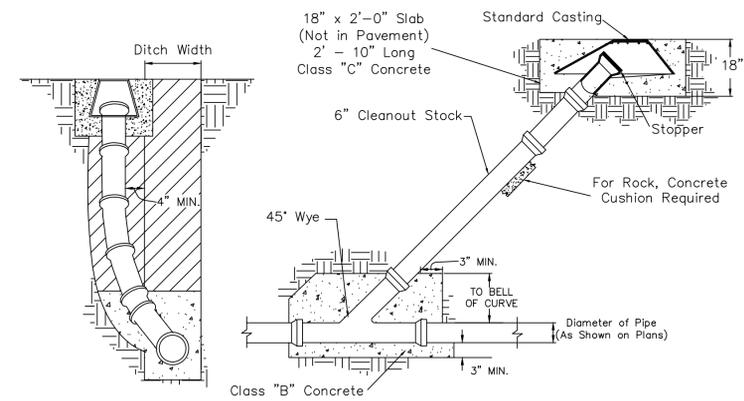


STANDARD CLEANOUT

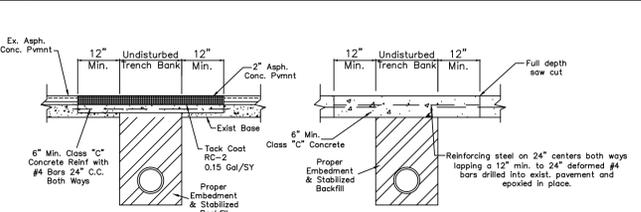


**STREET OR ALLEY REPAIR
AFTER UTILITY CUT**

SEE NOTE 3.B. ON SHEET C-6

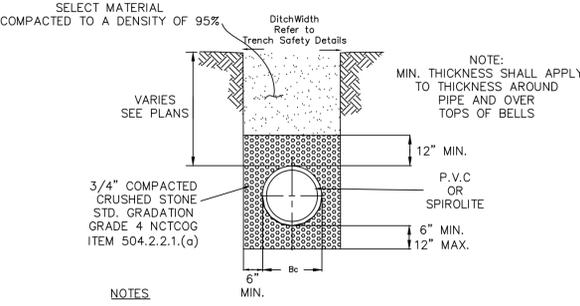

- NOTES:**
- Standard Embedment for Sanitary Sewer, or Design Engineer shall specify other Embedment to meet TCEQ Specifications Section 317.2
 - In Rock Trenches the minimum undercut will be 6".
 - FOR FORCE MAINS AND O-RING PIPE, SEE MANUF. SPECS. FOR EMBEDMENT.

EMBEDMENT FOR SEWER CONDUITS

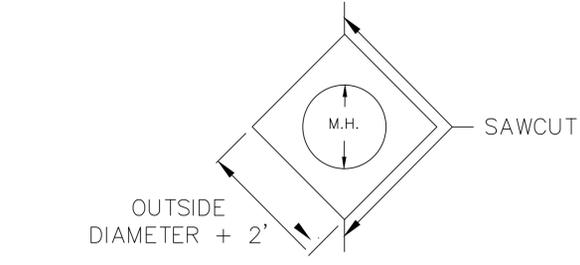

MANHOLE BLOCKOUT

Revisions:

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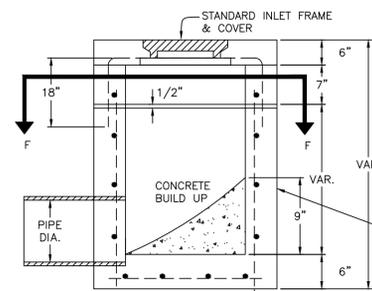
**STANDARD
DETAILS**

City of Richardson, Texas

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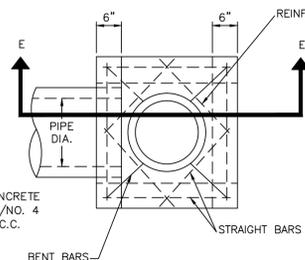
24"x36" Scale: NTS
11"x17" Scale: NTS
Vertical Scale: NA
Project Number: XXX
Issue Date: 01 MAY 14
Sheet Title:
SANITARY SEWER

Sheet No.:
C-4




SECTION EE

NOTE:
TOP OF INLET ELEVATION SHALL BE AT OR BELOW THE LOWEST ADJACENT CURB.




PLAN


"Y" TYPE INLET

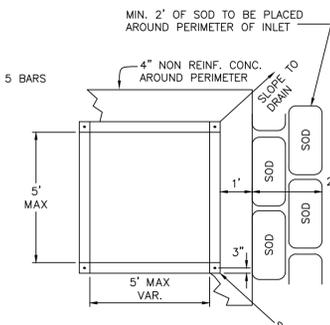


SECTION FF

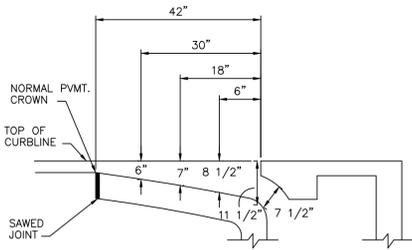


INLET THROAT DETAIL

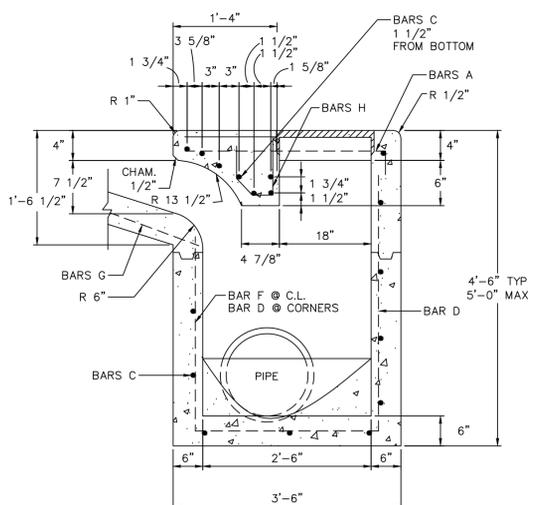


**END VIEW
6, 8, & 10 FT. INLETS**

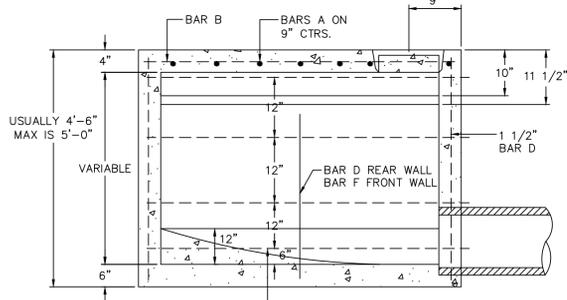

**FRONT VIEW
6, 8, & 10 FOOT INLETS**

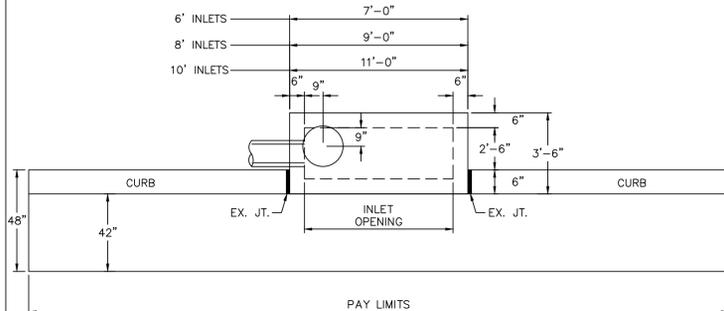


PLAN

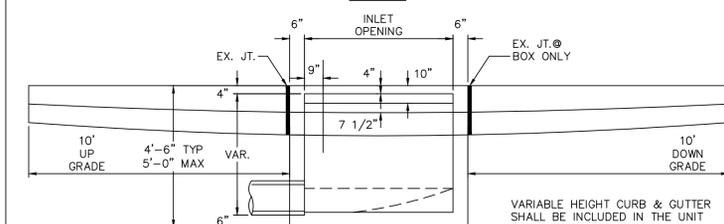


SECTION

**6, 8, & 10 FT. INLETS
(SEE INLET THROAT DETAIL)**

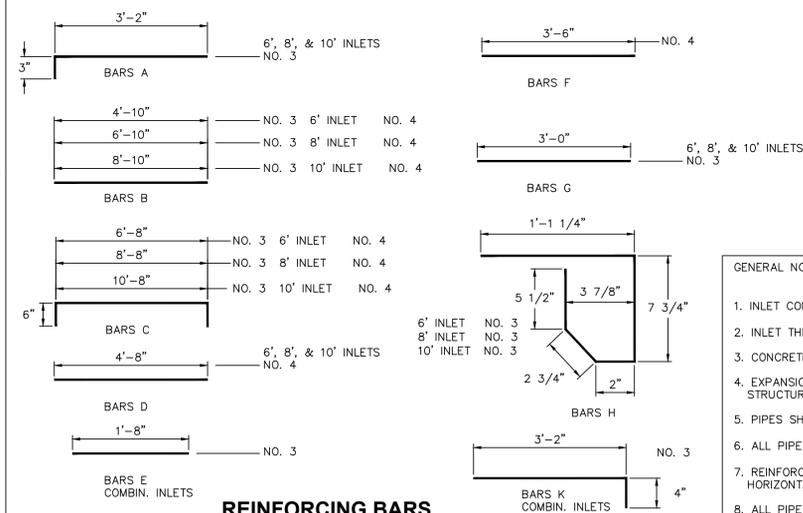


REINFORCING BARS

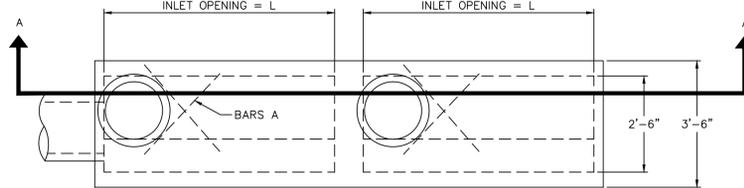


**PLAN
COMBINATION INLETS**

TO BE USED IN CONSTRUCTING 12', 14', 16', 18' & 20' INLETS

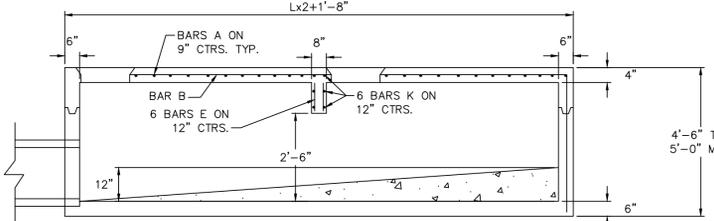

**SECTION A-A
COMBINATION INLETS**

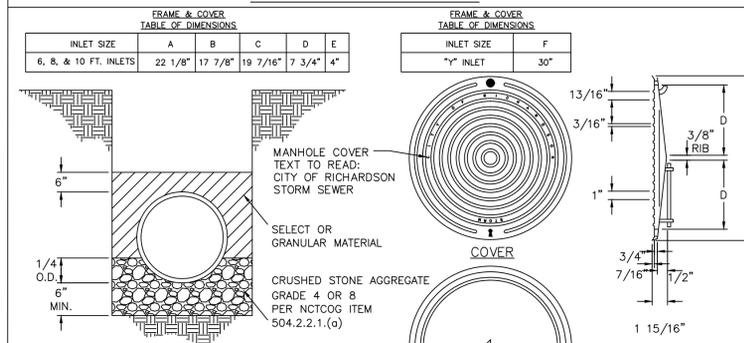


EMBEDMENT

NOTE:
MINIMUM TRENCH WIDTH SHALL BE THE OUTSIDE DIAMETER OF THE PIPE USED PLUS 16" FOR PIPE WITH 33" DIA. OR SMALLER. FOR PIPES LARGER THAN 33" SHALL BE THE O.D. PLUS 24".




**INLET FRAME & COVER
(LOCKING TYPE)**

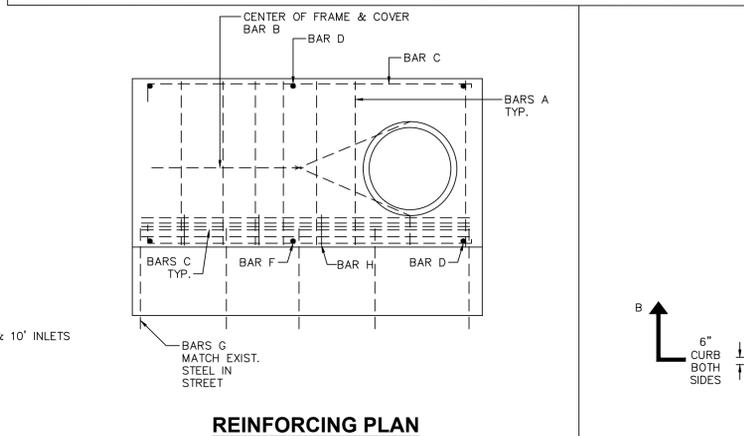


REINFORCING PLAN

- GENERAL NOTES**
1. INLET CONCRETE SHALL BE CLASS "A".
 2. INLET THROAT CONCRETE SHALL BE CLASS "C".
 3. CONCRETE SHALL HAVE A TROWEL AND BRUSH FINISH.
 4. EXPANSION JOINT MATERIAL SHALL BE PLACED BETWEEN INLET STRUCTURE AND CURB.
 5. PIPES SHALL ONLY CONNECT TO THE ENDS OR SIDES OF INLETS.
 6. ALL PIPE CONNECTIONS 48" AND SMALLER SHALL BE FACTORY WYES.
 7. REINFORCING STEEL- NO. 3 12" O.C.E.W. EQUALLY SPACED HORIZONTALLY IN INLET FOOTINGS.
 8. ALL PIPE JOINTS SHALL SHOW EVIDENCE OF JOINT MATERIAL 360° ON INSIDE OF PIPE.
 9. NO PRECAST STRUCTURES ALLOWED FOR STORM SEWER.
 10. SEE SHEET C-10 FOR STORM SEWER MANHOLE DETAILS.
 11. SEE C-9 FOR ALLEY INLETS.

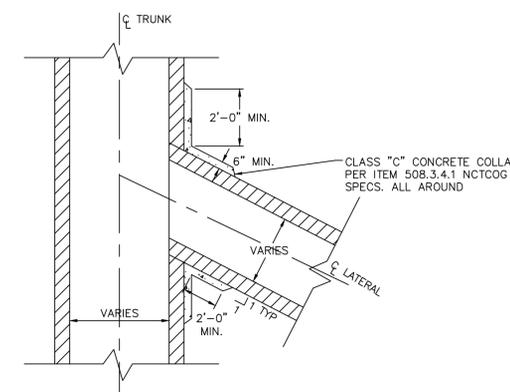


CONCRETE COLLAR FOR WYE CONNECTION


NOTE:
ALL PIPE CONNECTIONS 48" AND SMALLER SHALL BE FACTORY WYES

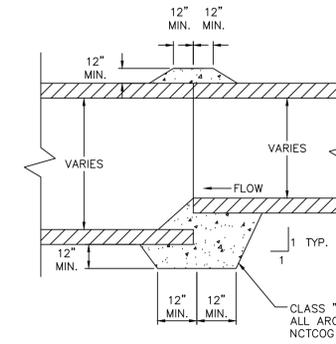

CONCRETE COLLAR FOR PIPE TO PIPE CONNECTION

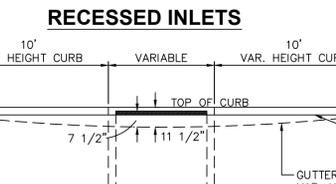

SECTION B-B

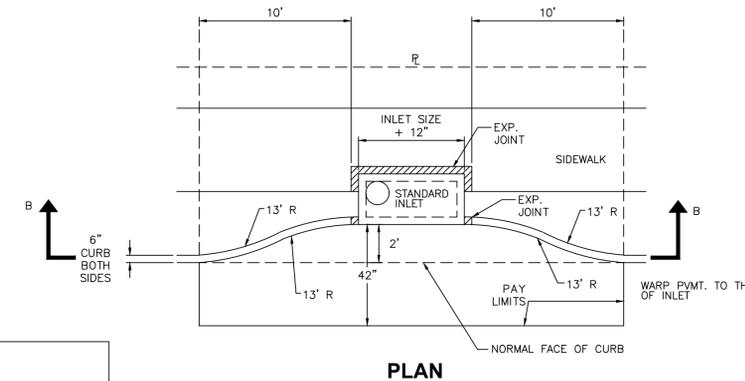

PLAN

Revisions:

City of Richardson
411 W. Arapaho Road
Suite 204
Richardson, Texas 75080
voice: 972 744-4280
fax: 972 744-5804

Drawn By: RGB
Checked By: COR



**STANDARD
DETAILS**
City of Richardson, Texas

NO ADDITIONS OR CHANGES TO STANDARD DETAIL SHEETS UNLESS APPROVED BY CITY OF RICHARDSON

24"x36" Scale: NTS

11"x17" Scale: NTS

Vertical Scale: NA

Project Number: XXX





Issue Date: 01 MAY 14

Sheet Title:

**STORM
SEWER**

Sheet No.:










C-5

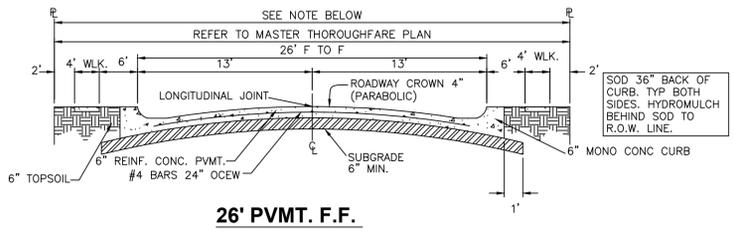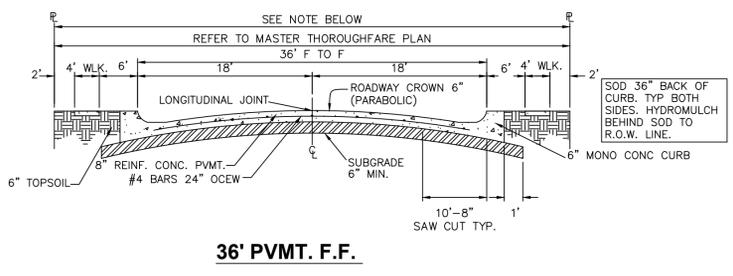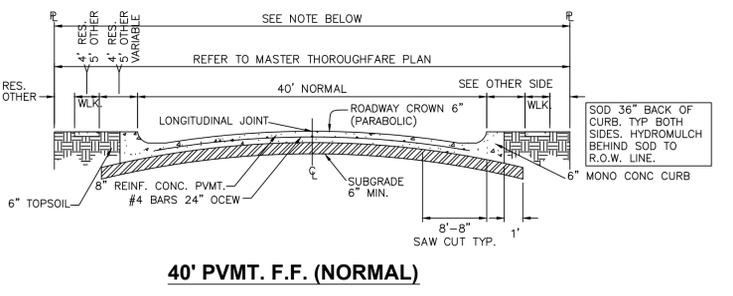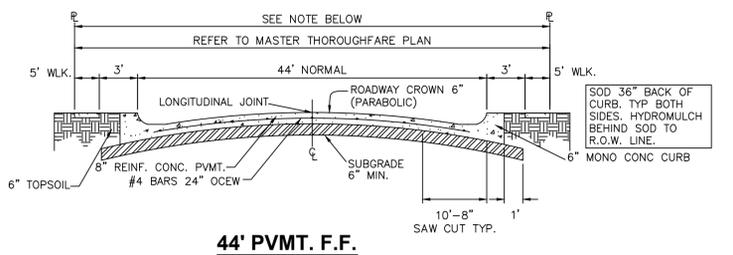

- NOTE:**
- ALL R.O.W. SHALL BE COMPACTED TO A MINIMUM OF 95% OF STANDARD PROCTOR @ -2% TO +4% OPTIMUM MOISTURE.
 - SIDEWALK WIDTH VARIES ACCORDING TO ZONING, AND PRESENCE OF SCREENING WALL.

TABLE OF CROWN HEIGHTS

ROADWAY WIDTH	TOTAL CROWN	3/4 POINT	MID-POINT	1/4 POINT
26'	4"	2-1/4"	1"	1/4"
36'	6"	3-3/8"	1 1/2"	3/8"
40'	6"	3-3/8"	1 1/2"	3/8"
44'	6"	3-3/8"	1 1/2"	3/8"

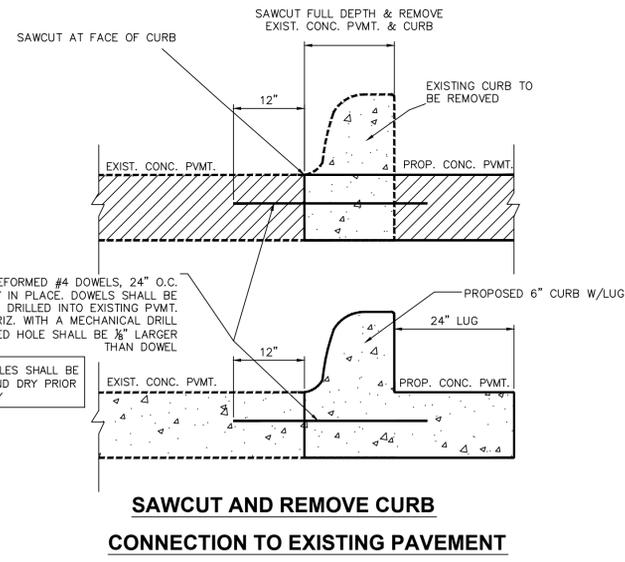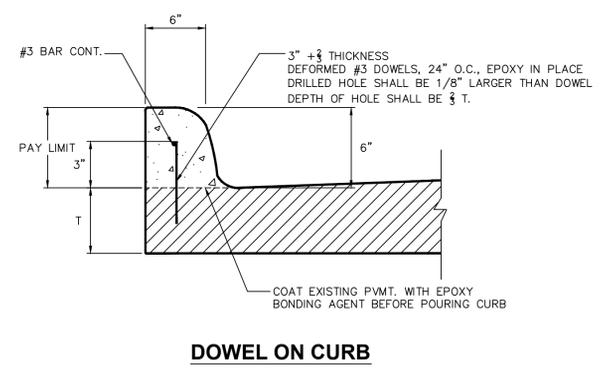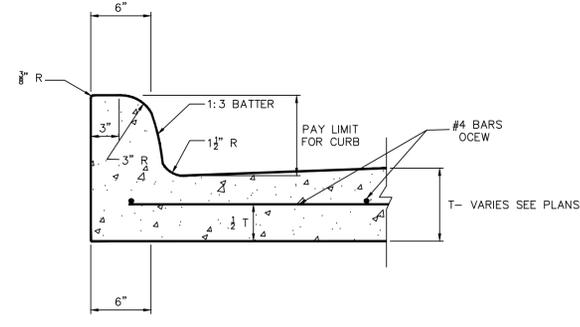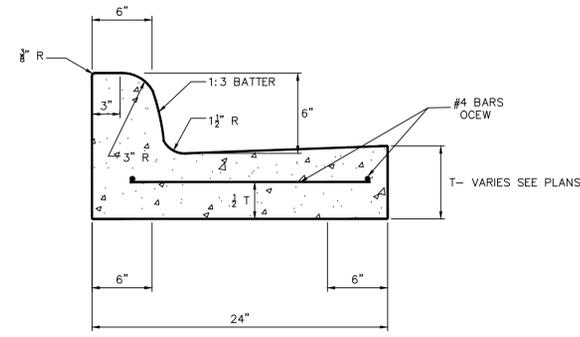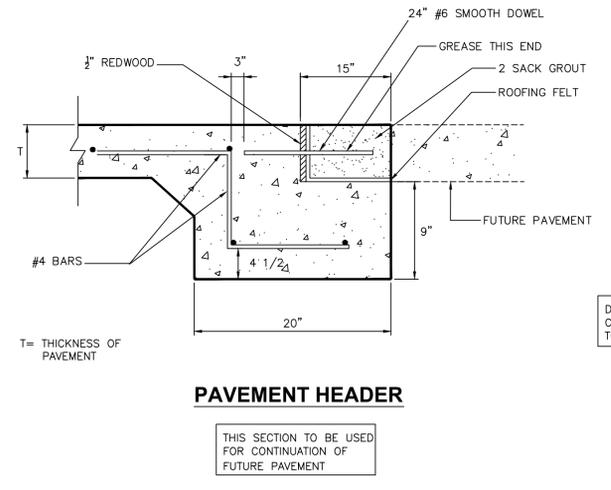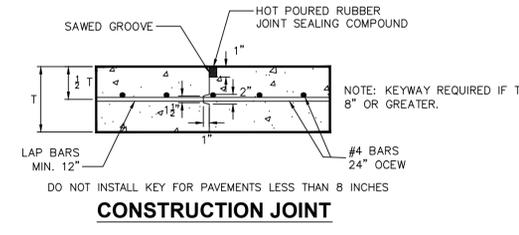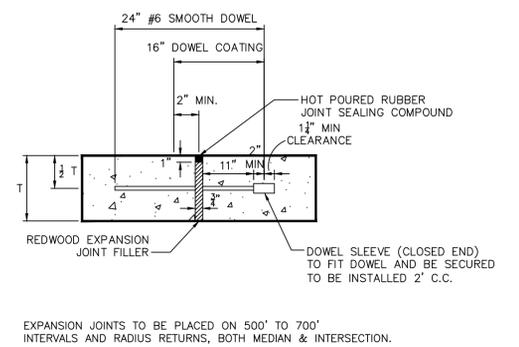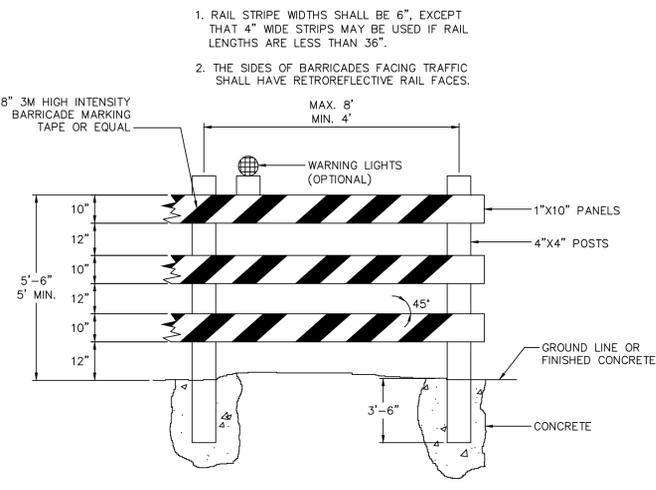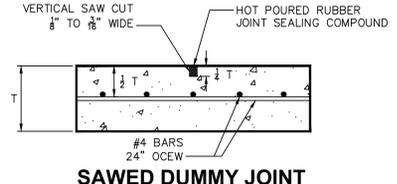

- NOTES:**
- STREET CONSTRUCTION SHALL CONFORM TO THE LATEST EDITION OF THE "STANDARD SPECIFICATIONS FOR PUBLIC WORKS CONSTRUCTION NORTH CENTRAL TEXAS." FOR THE DESIGN OF WATER AND SEWER LINES AND WATER DEPARTMENT STANDARDS.
 - ALL STREET PAVEMENT SHALL BE CLASS "C" CONCRETE PER NCTCOG ITEM 303.3.4.2(a), REINFORCED WITH #4 BARS, GRADE 60 SHOWN BOTH SPACED 24" O.C.E.W. HAND FINISHING WILL BE AS PER ITEM 303.5.6.2
 - ALL PARKWAYS SHALL SLOPE A MIN. OF 1/4" PER FOOT UP FROM THE CURB TO THE RIGHT-OF-WAY LINE, THEN AT A MAX 3:1 SLOPE TO MATCH EXISTING GRADE.
 - SAWING AND SEALING OF ALL LONGITUDINAL AND TRANSVERSE PAVEMENT JOINTS SHALL BE CONSIDERED SUBSIDIARY TO ALL PAVING ITEMS.
 - FOR PLACING OF CONCRETE PAVEMENT REFER TO ITEM 303.5.5 OF "STANDARD SPECIFICATIONS FOR PUBLIC WORKS CONSTRUCTION NORTH CENTRAL TEXAS."
 - FOR MAXIMUM SLUMP OF CONCRETE FOR PAVEMENT REFER TO ITEM 303.3.4.4 OF "STANDARD SPECIFICATIONS FOR PUBLIC WORKS CONSTRUCTION NORTH CENTRAL TEXAS."
 - ALL NONRESIDENTIAL PAVEMENT SHALL BE A MINIMUM OF 8" THICK, REINFORCED WITH #4 BARS, GRADE 60.
 - ALL COMMERCIAL AND RESIDENTIAL DRIVEWAYS SHALL BE CLASS "C" CONCRETE WITH #4 BARS GRADE 60 SPACED AT 24" OCEW.
- PORTLAND CEMENT CONCRETE PAVEMENT:**
- STANDARD SPECIFICATIONS ITEM 303.2.1.3 - "COARSE AGGREGATES" SHALL BE AMENDED THE FIRST SENTENCE IS DELETED AND REPLACED AS FOLLOWS "COARSE AGGREGATES SHALL BE 100% CRUSHED STONE"
 - STANDARD SPECIFICATIONS ITEM 303 SHALL BE AMENDED AS FOLLOWS:
 - ITEM 303.2.4. FLY ASH IS ALLOWED: MAX 20% BY WEIGHT
 - ITEM 303.2.5 SHALL BE DELETED. NO MINERAL FILLER IS ALLOWED
 - ITEM 303.2.6 SHALL BE DELETED. NO FIBROUS REINFORCEMENT ALLOWED
 - STANDARD SPECIFICATIONS ITEM 303 SHALL BE AMENDED TO INCLUDE THE FOLLOWING:
 - ALL EQUIPMENT NECESSARY TO CONSTRUCT CONCRETE PAVEMENT SHALL BE APPROVED BY THE OWNER PRIOR TO STARTING THE PAVING OPERATION. PAVING EQUIPMENT REQUIREMENTS ARE
 - SIDEWALKS LESS THAN 8" IN WIDTH
NO PAVING MACHINE REQUIRED. STINGER VIBRATORS AND METAL STRAIGHT EDGES SHALL BE USED TO CONSOLIDATE THE CONCRETE.
 - SIDEWALKS 8" IN WIDTH OR WIDER
VIBRATING SCREED WITH TWO HAND HELD STINGER VIBRATORS SHALL BE USED TO CONSOLIDATE THE CONCRETE.
 - PARKING LOTS AND TURN LANES
VIBRATING SCREED WITH TWO HAND HELD STINGER VIBRATORS SHALL BE USED TO CONSOLIDATE THE CONCRETE.
 - NEW STREET AND ALLEY PAVEMENT
SLIPFORM PAVING EQUIPMENT AS DESCRIBED IN ITEM 303.4.3 OF THE STANDARD SPECIFICATIONS SHALL BE USED.
 - STREET AND ALLEY REPAIRS
PAVING EQUIPMENT WILL BE DETERMINED BY THE OWNER.
 - FULL WIDTH ALLEY REPLACEMENT
VIBRATING SCREED WITH TWO HAND HELD STINGER VIBRATORS SHALL BE USED TO CONSOLIDATE THE CONCRETE.

- CONCRETE FINISH
NEW PAVEMENT: STREET AND ALLEY PAVEMENT SHALL BE TEXTURED WITH A NYLON BAKER BROOM THAT IS CLEAN AND FREE OF GROUT BUILDUP. DRAG BROOM LONGITUDINALLY OVER THE PAVEMENT AFTER BLEED WATER HAS EVAPORATED (CONCRETE WILL APPEAR DULL) BUT BEFORE CONCRETE HAS ATTAINED ITS INITIAL SET.
NEW SIDEWALK: SHALL BE TEXTURED WITH A TRANSVERSELY WITH A LIGHT BROOM FINISH. HAND FINISHING SHALL BE PER ITEM 303.5.6.2
- PAVEMENT PATCHING: STREET AND ALLEY PAVEMENT SHALL BE TEXTURED LONGITUDINALLY WITH A HORSEHAIR BROOM OR A BURLAP DRAG FINISH.

C. CONCRETE TEMPERATURES

MAY 1 THROUGH SEPTEMBER 30

- ALL MIXES AND MIX DESIGNS SHALL INCLUDE A RETARDING AGENT.
- CONCRETE TEMPERATURE PRIOR TO PLACEMENT SHALL NOT EXCEED 95°F. (35°C).
- THE TIME INTERVAL (FROM ADDITION OF INITIAL WATER):

AGITATED CONCRETE		
90°F OR ABOVE (32.2°C)	45 MINUTES	
75°F TO 89°F (23.9° TO 31.6°C)	60 MINUTES	
35°F TO 74°F (1.6° TO 23.3°C)	90 MINUTES	

NON AGITATED CONCRETE		
80°F OR ABOVE (26.6°C)	15 MINUTES	
35°F TO 79°F (1.6° TO 26.1°C)	30 MINUTES	

OCTOBER 1 THROUGH APRIL 30

- CONCRETE TEMPERATURE PRIOR TO PLACEMENT SHALL NOT EXCEED 95°F. (35°C).
- THE TIME INTERVAL (FROM ADDITION OF INITIAL WATER):


AGITATED CONCRETE		
90°F OR ABOVE (32.2°C)	45 MINUTES	
75°F TO 89°F (23.9° TO 31.6°C)	60 MINUTES	
35°F TO 74°F (1.6° TO 23.3°C)	90 MINUTES	

NON AGITATED CONCRETE		
80°F OR ABOVE (26.6°C)	15 MINUTES	
35°F TO 79°F (1.6° TO 26.1°C)	30 MINUTES	

Revisions:

City of Richardson
411 W. Arapaho Road
Suite 204
Richardson, Texas 75080
voice: 972 744-4280
fax: 972 744-5804

Drawn By: RGB
Checked By: COR

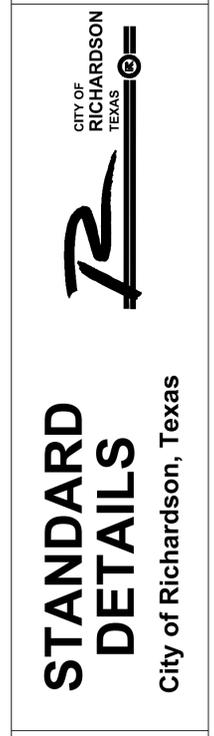

NO ADDITIONS OR CHANGES TO STANDARD DETAIL SHEETS UNLESS APPROVED BY CITY OF RICHARDSON

24"x36" Scale: NTS

11"x17" Scale: NTS


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Project Number: XXX

Issue Date: 01 MAY 14


Sheet Title: **STREET**

Sheet No.: **C-6**

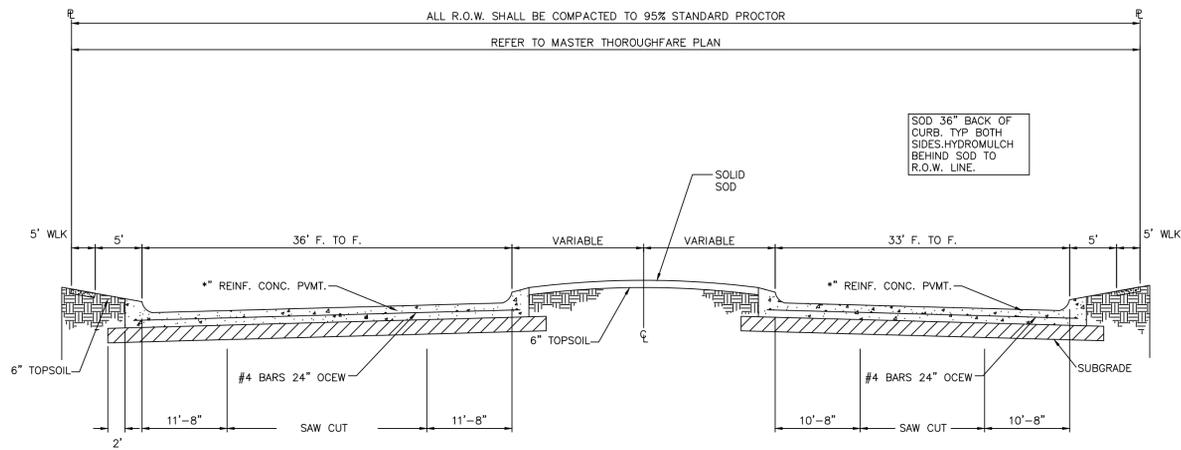


36'-33' PVMT. F.F.


* 8" THK WITH LIME TREATED SUBGRADE
 9" THK WITHOUT LIME TREATED SUBGRADE
 10" THK AT ALL THOROUGHFARE TO THOROUGHFARE INTERSECTIONS, FROM RADIUS RETURN TO RADIUS RETURN

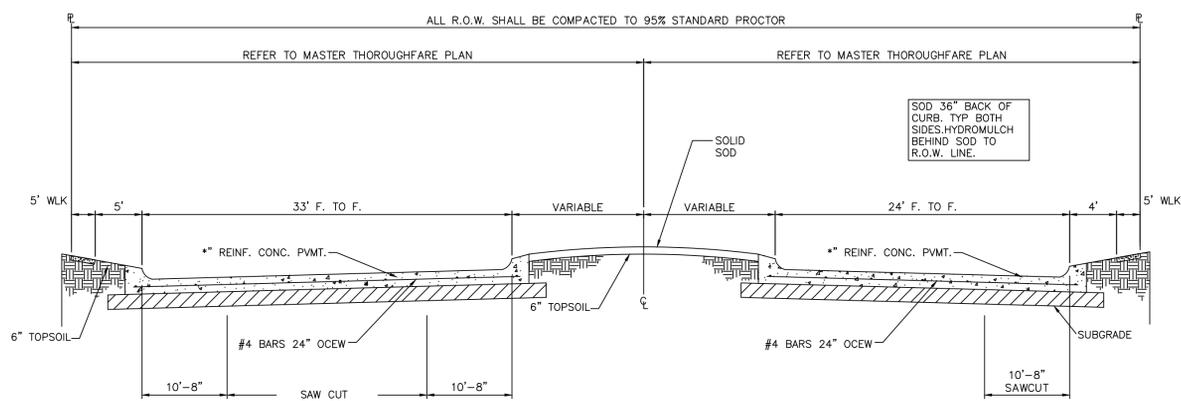


**22'-33' PVMT. F.F.
 TYPICAL PVMT. SECTION-DIVIDED ROADWAY**

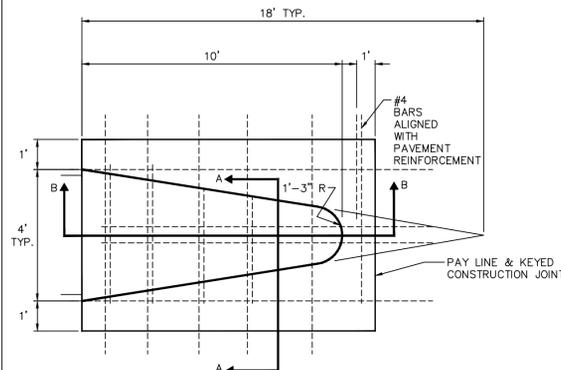


MONOLITHIC MEDIAN NOSE

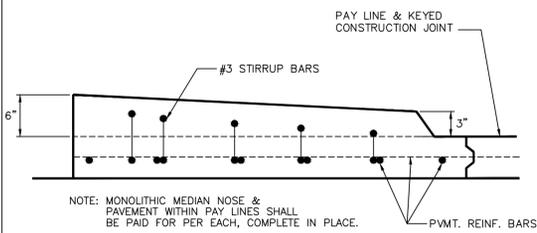

SECTION B-B

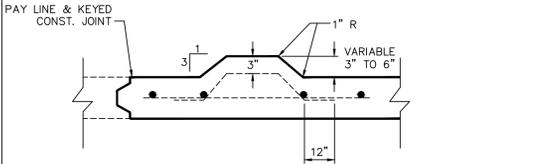

SECTION A-A

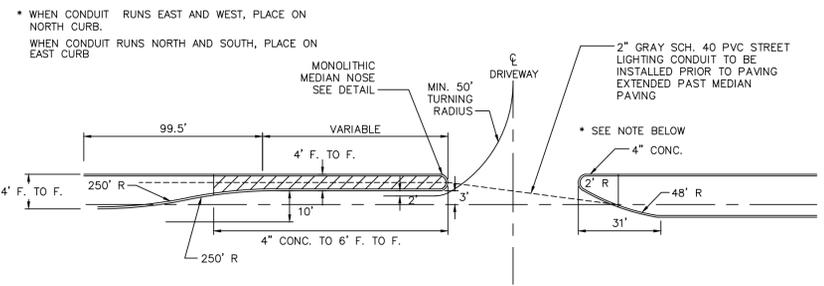


• WHEN CONDUIT RUNS EAST AND WEST, PLACE ON NORTH CURB.
 WHEN CONDUIT RUNS NORTH AND SOUTH, PLACE ON EAST CURB

SEE STREET MARKING STANDARD DETAIL FOR BUTTON TYPE AND LOCATION

LEFT TURN LANE FOR 14 FOOT MEDIAN

ALL DIMENSIONS ARE TO FACE OF CURB UNLESS OTHERWISE NOTED

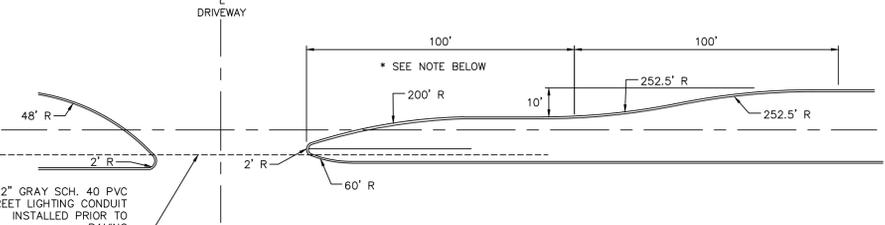


• WHEN CONDUIT RUNS EAST AND WEST, PLACE ON NORTH CURB.
 WHEN CONDUIT RUNS NORTH AND SOUTH, PLACE ON EAST CURB


* STREET LIGHTING CONDUIT
 WHEN CONDUIT RUNS EAST AND WEST, PLACE ON NORTH CURB
 WHEN CONDUIT RUNS NORTH AND SOUTH, PLACE ON EAST CURB

SEE STREET MARKING STANDARD DETAIL FOR BUTTON TYPE AND LOCATION


LEFT TURN LANE FOR 28 FOOT (OR LARGER) MEDIAN

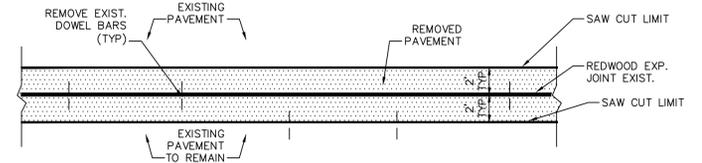


REPLACE PLAN

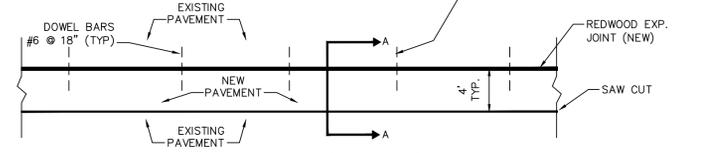

EXISTING PLAN

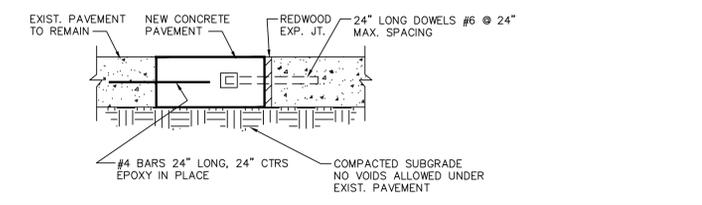


REDWOOD EXPANSION JOINT REPLACEMENT CURB TO CURB ONLY

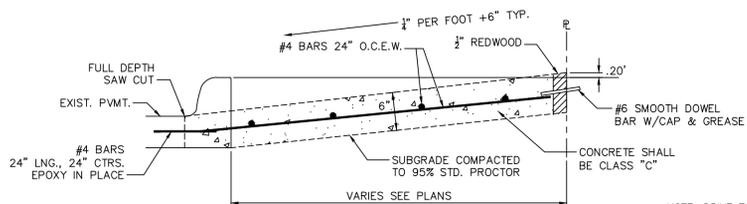


TYP. COMMERCIAL DRIVE APPROACH


NOTE: DRIVE TO HAVE MAXIMUM OF 2% CROSS SLOPE @ SIDEWALK CROSSING

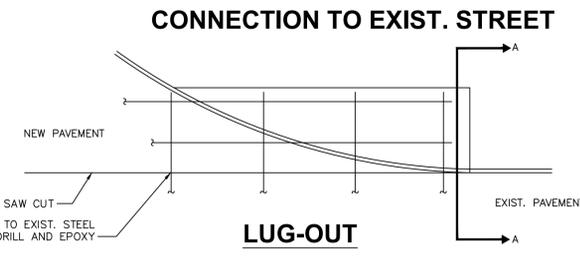

LUG-OUT

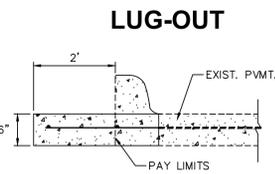

SECTION A-A

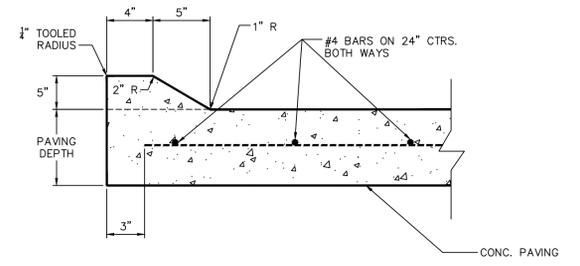

MOUNTABLE MONOLITHIC CURB TYPE 1

- NOTES:
- STREET CONSTRUCTION SHALL CONFORM TO THE LATEST EDITION OF THE "STANDARD SPECIFICATIONS FOR PUBLIC WORKS CONSTRUCTION NORTH CENTRAL TEXAS."
 - ALL STREET PAVEMENT SHALL BE CLASS "C" CONCRETE PER ITEM 303.3.4.2, REINFORCED WITH #4 BARS, GRADE 60 SHOWN BOTH SPACED 24" O.C.E.W. HAND FINISHING WILL BE AS PER ITEM 303.5.6.2.
 - ALL PARKWAYS SHALL SLOPE A MIN. OF 1/4" PER FOOT UP FROM THE CURB TO THE RIGHT-OF-WAY LINE, THEN AT A MAX 3:1 SLOPE TO MATCH EXISTING GRADE.
 - SAWING AND SEALING OF ALL LONGITUDINAL AND TRANSVERSE PAVEMENT JOINTS SHALL BE CONSIDERED SUBSIDIARY TO ALL PAVING ITEMS.
 - FOR PLACING OF CONCRETE PAVEMENT REFER TO ITEM 303.5.5 OF "STANDARD SPECIFICATIONS FOR PUBLIC WORKS CONSTRUCTION NORTH CENTRAL TEXAS."
 - FOR MAXIMUM SLUMP OF CONCRETE FOR PAVEMENT REFER TO ITEM 303.3.4.4 OF "STANDARD SPECIFICATIONS FOR PUBLIC WORKS CONSTRUCTION NORTH CENTRAL TEXAS."
 - ALL MEDIAN PAVEMENT SHALL BE CLASS "A" CONCRETE, REINFORCED WITH #4 BARS, GRADE 60, MIN. AT 24" O.C.E.W.

Revisions:

City of Richardson
 411 W. Arapaho Road
 Suite 204
 Richardson, Texas 75080
 voice: 972 744-4280
 fax: 972 744-5804


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 Checked By: COR

CITY OF RICHARDSON TEXAS


STANDARD DETAILS
 City of Richardson, Texas

NO ADDITIONS OR CHANGES TO STANDARD DETAIL SHEETS UNLESS APPROVED BY CITY OF RICHARDSON


24"x36" Scale: NTS
 11"x17" Scale: NTS
 Vertical Scale: NA
 Project Number: XXX
 Issue Date: 01 MAY 14
 Sheet Title: **STREET**
 Sheet No.: **C-7**

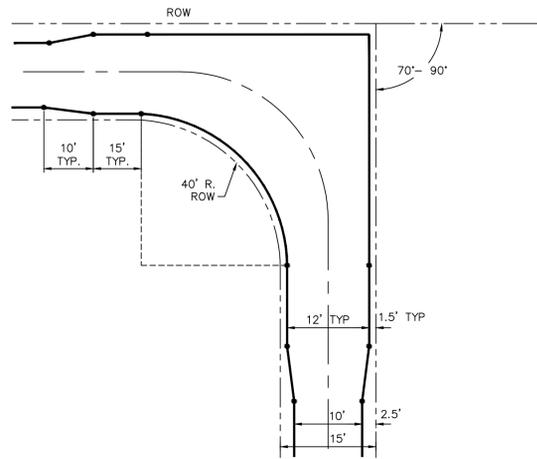


ALLEY INTERSECTION DETAIL

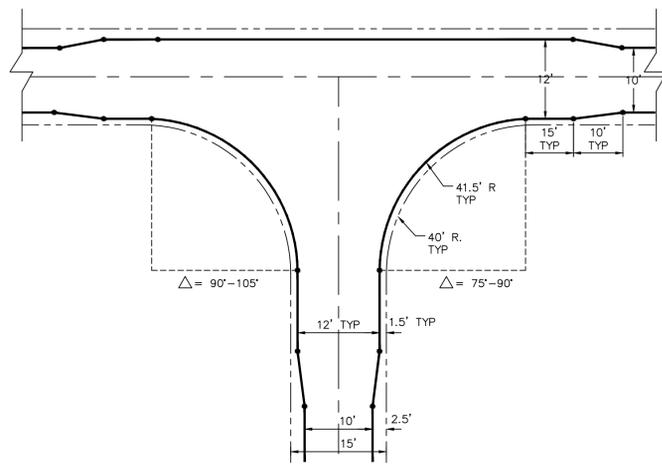


ALLEY INTERSECTION DETAIL

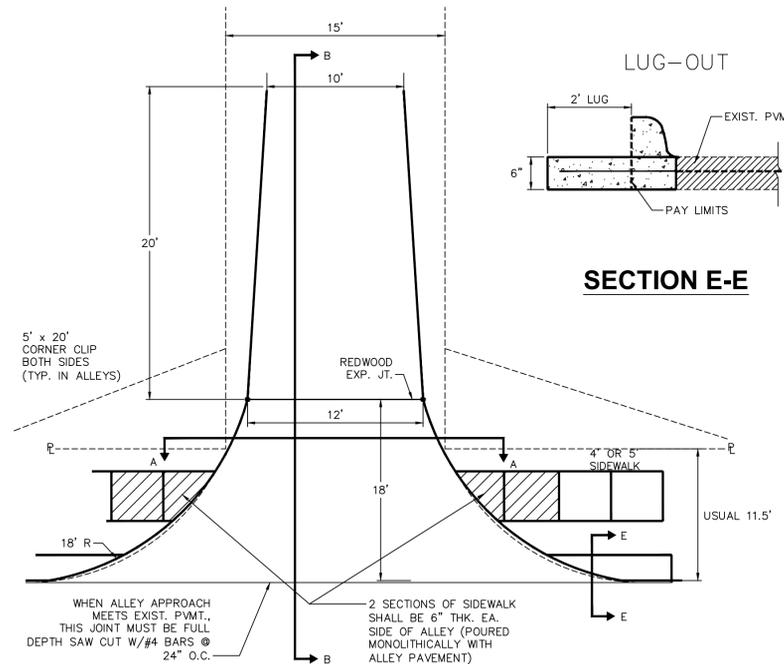


ALLEY APPROACH DETAIL

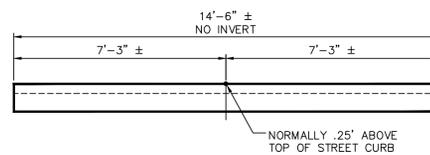

SECTION A-A

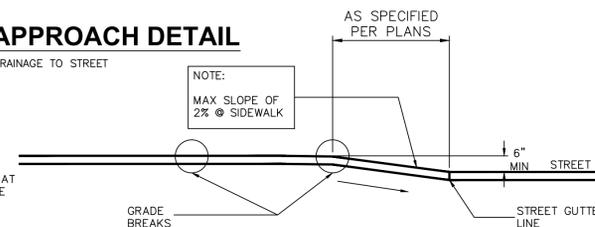


SECTION B-B

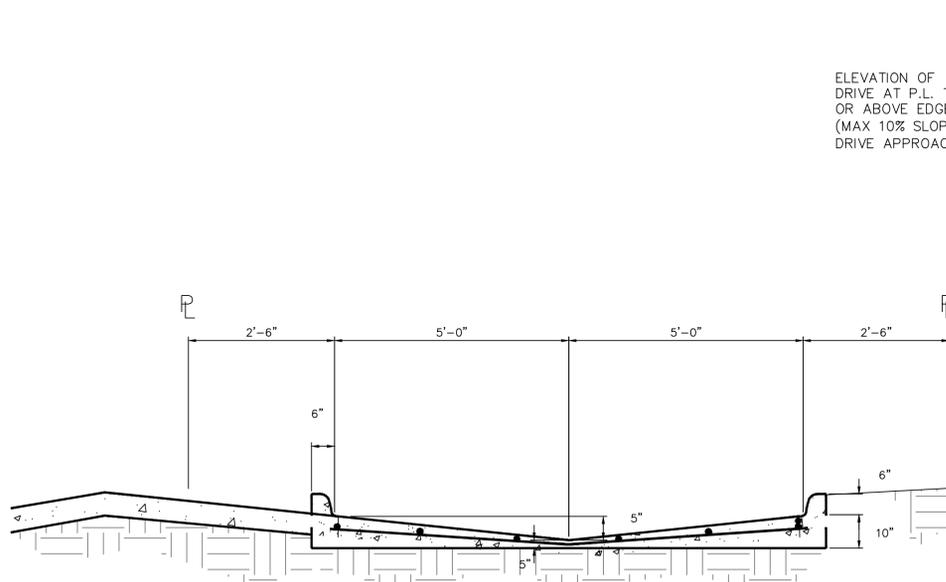

STANDARD ALLEY DETAIL

ALTERNATE ALLEY CROSS SECTION MAY BE USED IN LIEU OF STANDARD CROSS SECTION HOWEVER, NO ADDITIONAL COMPENSATION WILL BE PROVIDED TO THE CONTRACTOR.

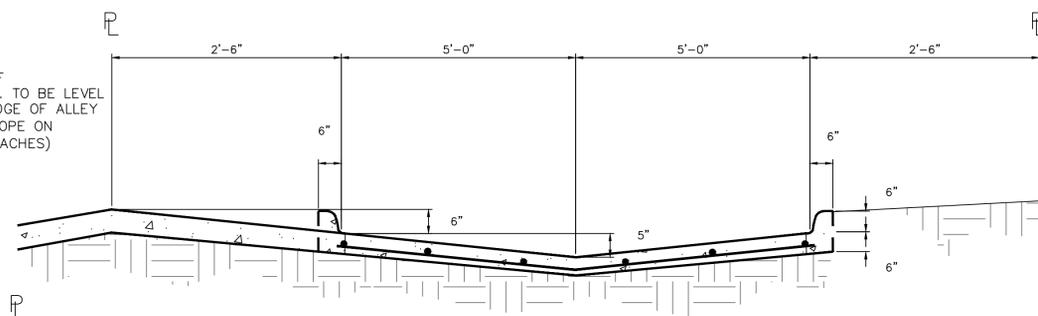

ALTERNATE ALLEY DETAIL (SLIP FORM ONLY)

NOTES:

1. ALL CONSTRUCTION SHALL CONFORM TO THE LATEST EDITION OF THE "STANDARD SPECIFICATIONS FOR PUBLIC WORKS CONSTRUCTION NORTH CENTRAL TEXAS."
2. ALL ALLEY PAVEMENT SHALL BE CLASS "C" CONCRETE PER ITEM 303.3.4.2, REINFORCED WITH #4 BARS, GRADE 60 SPACED 24" O.C.E.W. ONE SACK OF CEMENT TO BE ADDED FOR HAND POURS
3. ALL JOINTS, SAWING AND SEALING OF LONGITUDINAL AND TRANSVERSE PAVEMENT JOINTS SHALL BE CONSIDERED SUBSIDIARY TO ALL PAVING ITEMS.
4. FOR PLACING OF CONCRETE PAVEMENT REFER TO ITEM 303.5.5.
5. FOR MAXIMUM SLUMP OF CONCRETE FOR PAVEMENT REFER TO ITEM 303.4.4.
6. ALTERNATE ALLEY CROSS SECTION MAY BE USED IN LIEU OF STANDARD ALLEY CROSS SECTION HOWEVER, NO ADDITIONAL COMPENSATION WILL BE PROVIDED TO THE CONTRACTOR.
7. SEE SHEET C-6 FOR JOINT DETAILS
8. INLETS SHALL NOT BE LOCATED IN ALLEY TRANSITIONS

PORTLAND CEMENT CONCRETE PAVEMENT

1. STANDARD SPECIFICATIONS ITEM 303.2.1.3 - "COARSE AGGREGATES" SHALL BE AMENDED THE FIRST SENTENCE IS DELETED AND REPLACED AS FOLLOWS "COARSE AGGREGATES SHALL BE 100% CRUSHED STONE"
2. STANDARD SPECIFICATIONS ITEM 303 SHALL BE AMENDED AS FOLLOWS:
 - A. ITEM 303.2.4. FLY ASH IS ALLOWED MAX 20% BY WEIGHT
 - B. ITEM 303.2.5 SHALL BE DELETED. NO MINERAL FILLER IS ALLOWED
 - C. ITEM 303.2.6 SHALL BE DELETED. NO FIBROUS REINFORCEMENT ALLOWED
3. STANDARD SPECIFICATIONS ITEM 303 SHALL BE AMENDED TO INCLUDE THE FOLLOWING:
 - A. ALL EQUIPMENT NECESSARY TO CONSTRUCT CONCRETE PAVEMENT SHALL BE APPROVED BY THE OWNER PRIOR TO STARTING THE PAVING OPERATION. PAVING EQUIPMENT REQUIREMENTS ARE AS FOLLOWS:
 1. **NEW STREET AND ALLEY PAVEMENT**
SLIPFORM PAVING EQUIPMENT AS DESCRIBED IN ITEM 303.4.3 OF THE STANDARD SPECIFICATIONS SHALL BE USED.
 2. **STREET AND ALLEY REPAIRS**
PAVING EQUIPMENT WILL BE DETERMINED BY THE OWNER.
 3. **FULL WIDTH ALLEY REPLACEMENT**
VIBRATING SCREED WITH TWO HAND HELD STINGER VIBRATORS SHALL BE USED TO CONSOLIDATE THE CONCRETE.
 - B. **CONCRETE FINISH**
NEW PAVEMENT: STREET AND ALLEY PAVEMENT SHALL BE TEXTURED WITH A NYLON BAKER BRUSH THAT IS CLEAN AND FREE OF GROUT BUILDUP. DRAG BROOM LONGITUDINALLY OVER THE PAVEMENT AFTER BLEED WATER HAS EVAPORATED (CONCRETE WILL APPEAR DULL) BUT BEFORE CONCRETE HAS ATTAINED ITS INITIAL SET.

C. CONCRETE TEMPERATURES

MAY 1 THROUGH SEPTEMBER 30

1. ALL MIXES AND MIX DESIGNS SHALL INCLUDE A RETARDING AGENT.
2. CONCRETE TEMPERATURE PRIOR TO PLACEMENT SHALL NOT EXCEED 95°F, (35°C).
3. THE TIME INTERVAL (FROM ADDITION OF INITIAL WATER):

AGITATED CONCRETE		
90°F OR ABOVE	(32.2°C)	45 MINUTES
75°F TO 89°F	(23.9° TO 31.6°C)	60 MINUTES
35°F TO 74°F	(1.6° TO 23.3°C)	90 MINUTES
NON AGITATED CONCRETE		
80°F OR ABOVE	(26.6°C)	15 MINUTES
35°F TO 79°F	(1.6° TO 26.1°C)	30 MINUTES

OCTOBER 1 THROUGH APRIL 30

1. CONCRETE TEMPERATURE PRIOR TO PLACEMENT SHALL NOT EXCEED 95°F, (35°C).
2. THE TIME INTERVAL (FROM ADDITION OF INITIAL WATER):

AGITATED CONCRETE		
90°F OR ABOVE	(32.2°C)	45 MINUTES
75°F TO 89°F	(23.9° TO 31.6°C)	60 MINUTES
35°F TO 74°F	(1.6° TO 23.3°C)	90 MINUTES
NON AGITATED CONCRETE		
80°F OR ABOVE	(26.6°C)	15 MINUTES
35°F TO 79°F	(1.6° TO 26.1°C)	30 MINUTES

Revisions:

City of Richardson
411 W. Arapaho Road
Suite 204
Richardson, Texas 75080
voice: 972 744-4280
fax: 972 744-5804

Drawn By: RGB
Checked By: COR

CITY OF RICHARDSON
TEXAS



**STANDARD
DETAILS**
City of Richardson, Texas

NO ADDITIONS OR CHANGES TO STANDARD DETAIL SHEETS UNLESS APPROVED BY CITY OF RICHARDSON

24"x36" Scale: NTS

11"x17" Scale: NTS

Vertical Scale: NA

Project Number: XXX


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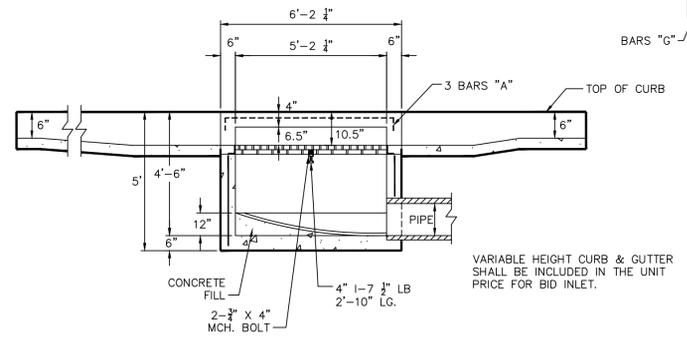
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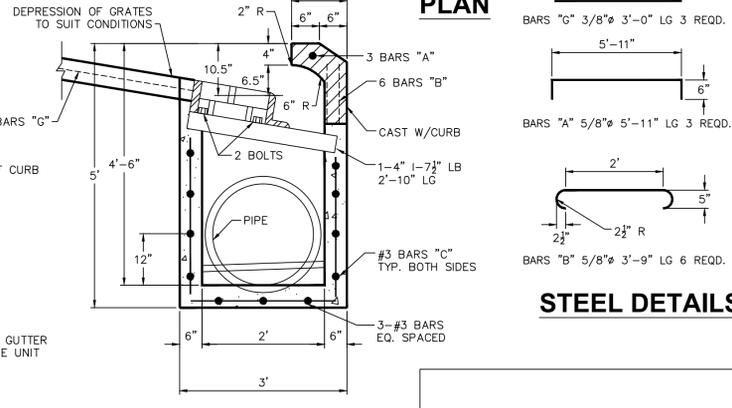
C-8



SECTION C-C



SECTION B-B

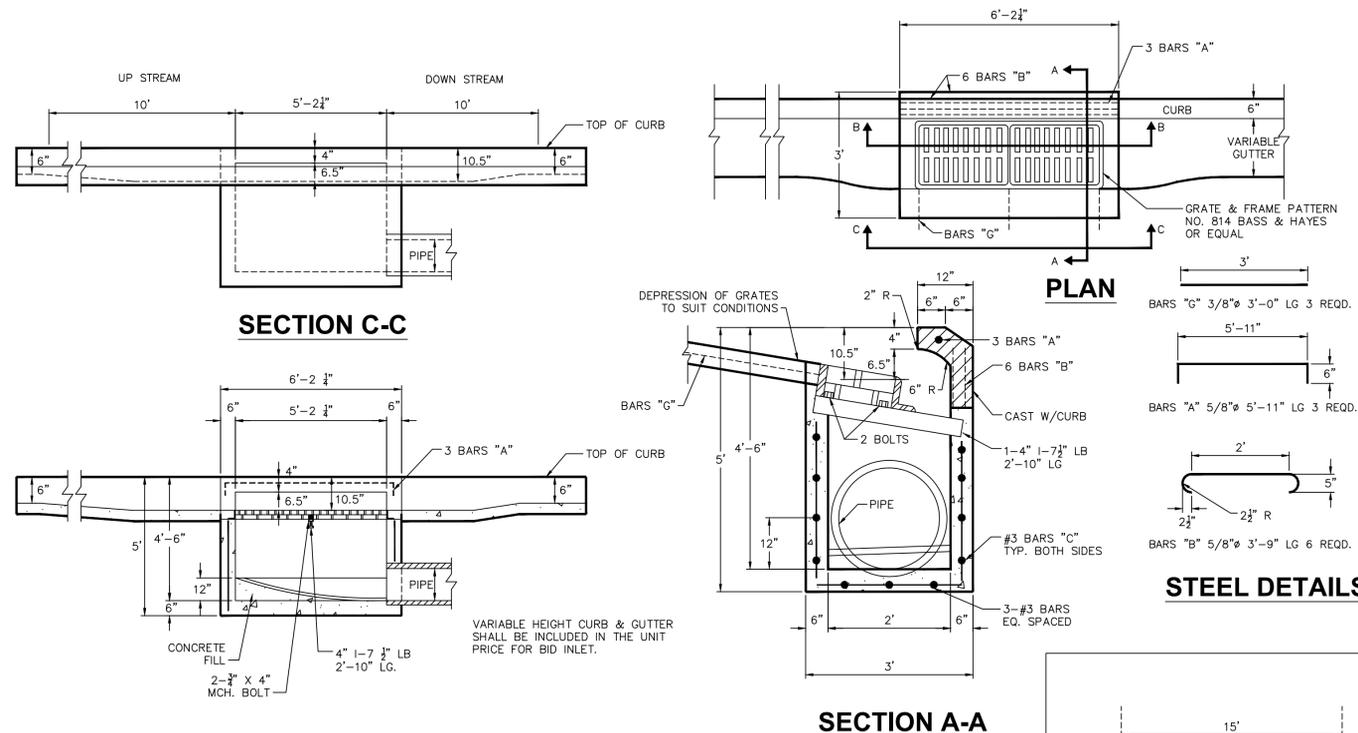


SECTION A-A

STEEL DETAILS

REINFORCING STEEL- NO. 3 1/2\"/>

DOUBLE GRATE INLET

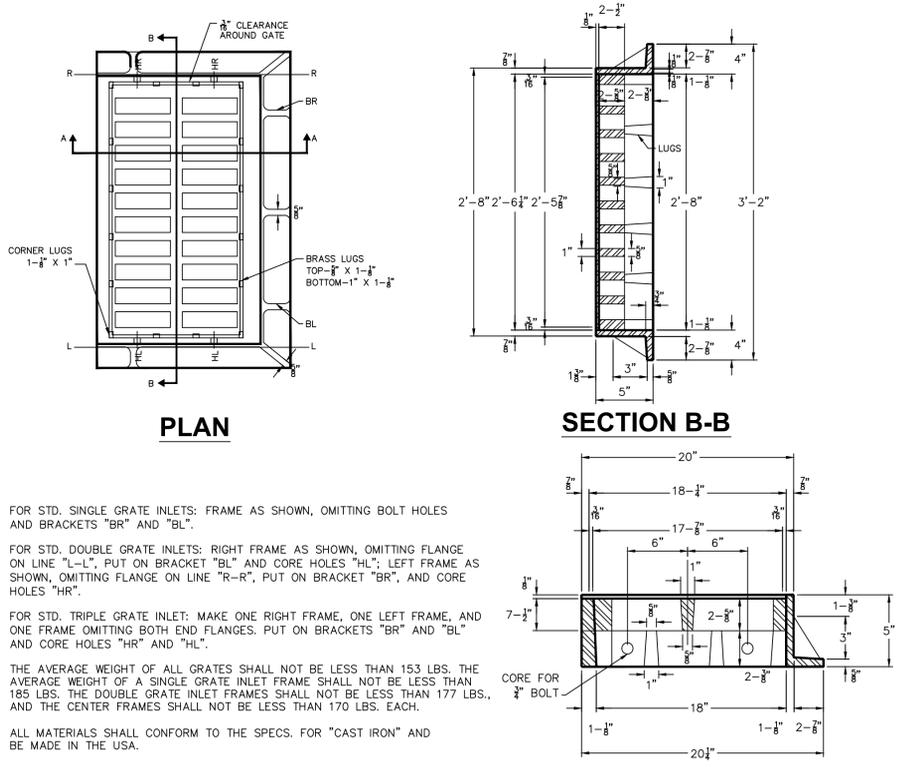


PLAN

SECTION B-B

SECTION A-A


FOR STD. SINGLE GRATE INLETS: FRAME AS SHOWN, OMITTING BOLT HOLES AND BRACKETS "BR" AND "BL".
 FOR STD. DOUBLE GRATE INLETS: RIGHT FRAME AS SHOWN, OMITTING FLANGE ON LINE "L-L", PUT ON BRACKET "BL" AND CORE HOLES "HL"; LEFT FRAME AS SHOWN, OMITTING FLANGE ON LINE "R-R", PUT ON BRACKET "BR", AND CORE HOLES "HR".
 FOR STD. TRIPLE GRATE INLET: MAKE ONE RIGHT FRAME, ONE LEFT FRAME, AND ONE FRAME OMITTING BOTH END FLANGES. PUT ON BRACKETS "BR" AND "BL" AND CORE HOLES "HR" AND "HL".
 THE AVERAGE WEIGHT OF ALL GRATES SHALL NOT BE LESS THAN 153 LBS. THE AVERAGE WEIGHT OF A SINGLE GRATE INLET FRAME SHALL NOT BE LESS THAN 185 LBS. THE DOUBLE GRATE INLET FRAMES SHALL NOT BE LESS THAN 177 LBS., AND THE CENTER FRAMES SHALL NOT BE LESS THAN 170 LBS. EACH.
 ALL MATERIALS SHALL CONFORM TO THE SPECS. FOR "CAST IRON" AND BE MADE IN THE USA.

INLET GRATE & FRAME

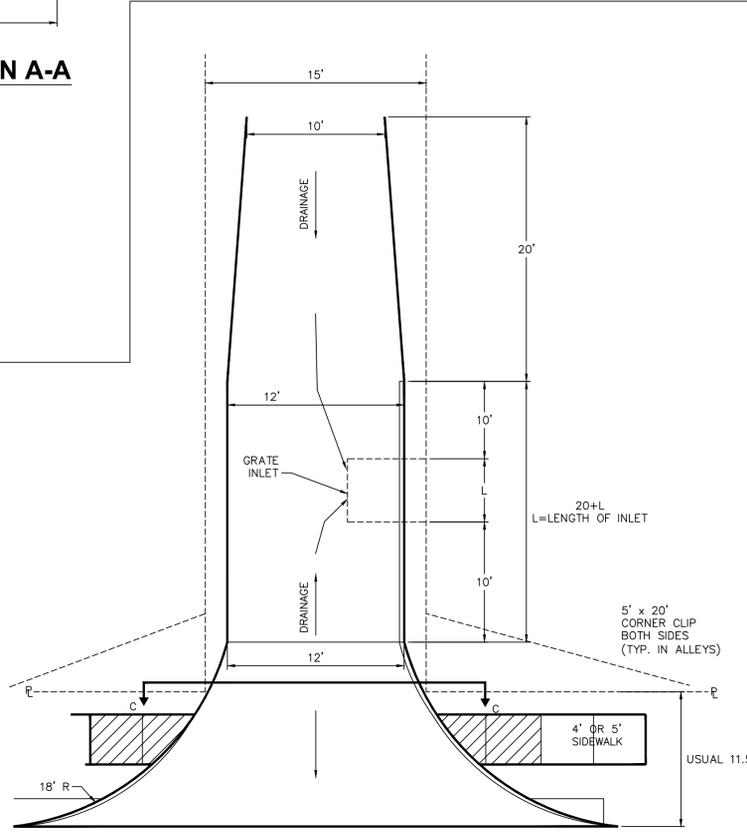


ALLEY W/GRATE INLET (INLET LOCATION)

SECTION C-C

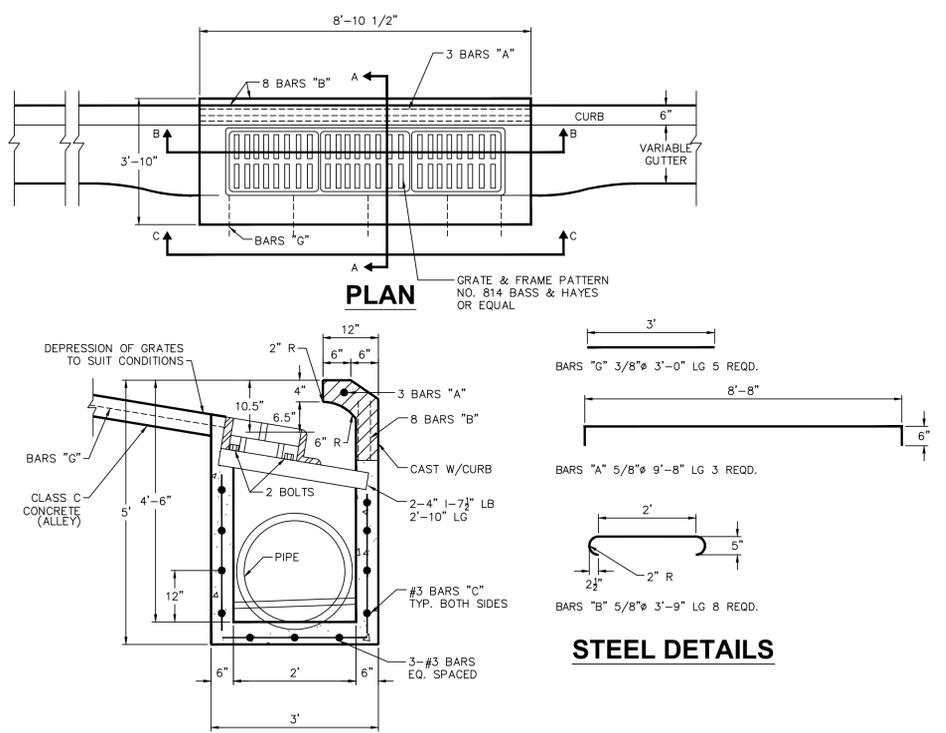


PLAN

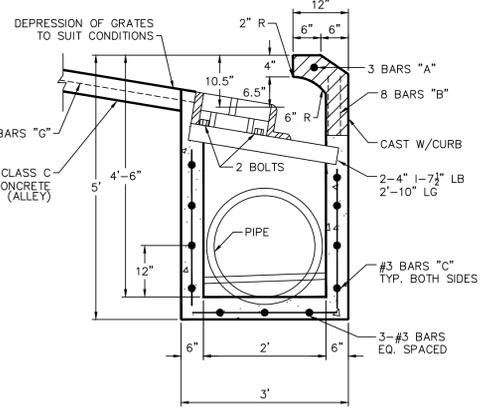


SECTION A-A

STEEL DETAILS

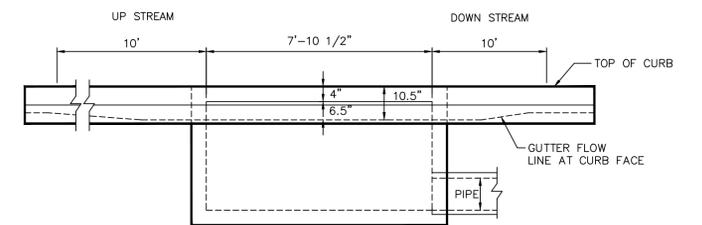

SECTION C-C

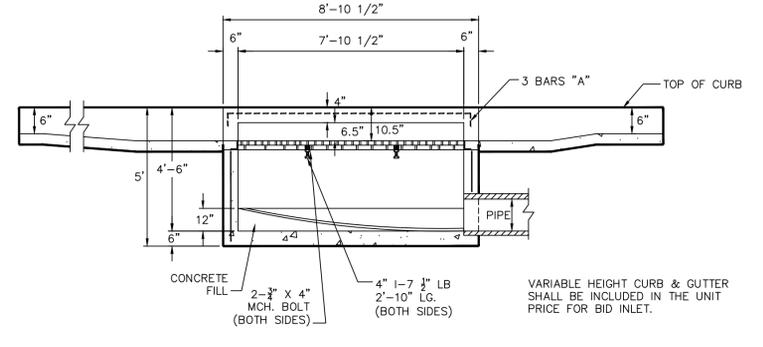

SECTION B-B

TRIPLE GRATE INLET

NOTES:
 1. CONCRETE SHALL BE CLASS A FOR INLET BOXES.
 2. ALLEY PAVEMENT SHALL BE CLASS C CONCRETE.


Revisions:

 City of Richardson
 411 W. Arapaho Road
 Suite 204
 Richardson, Texas 75080
 voice: 972 744-4280
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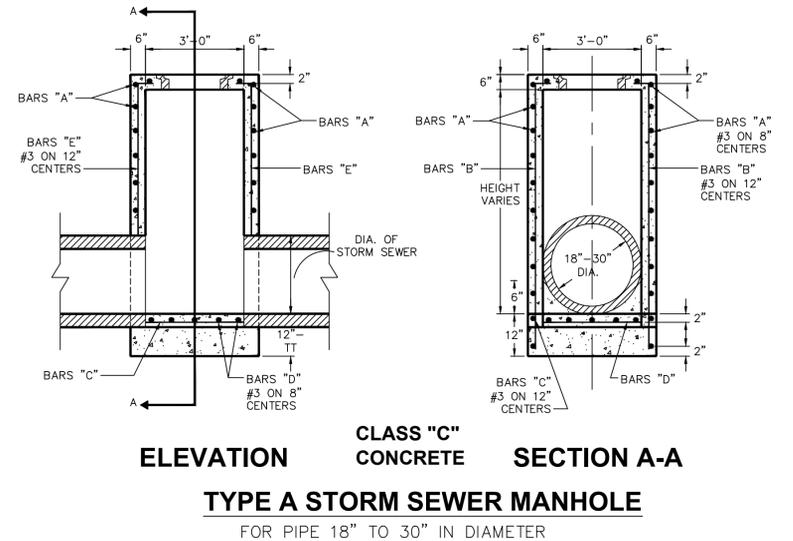


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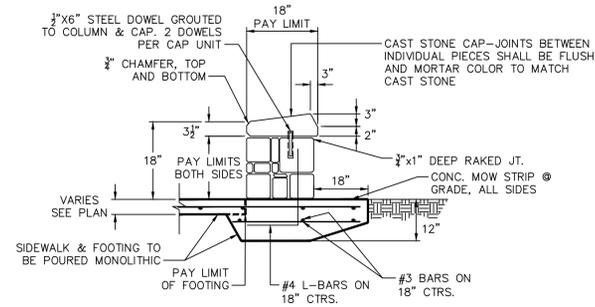
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 Project Number: XXX
 Issue Date: 01 MAY 14
 Sheet Title: ALLEY
 Sheet No.:




SECTION B-B

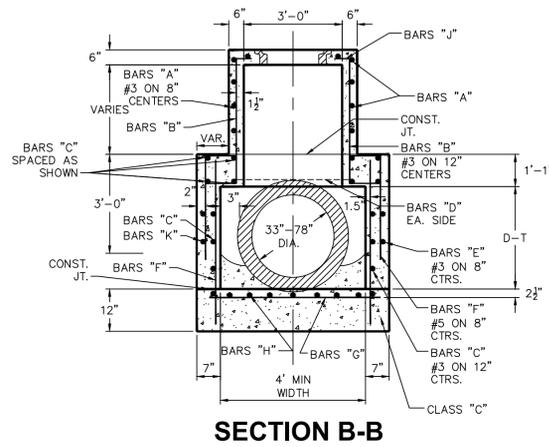


ELEVATION SECTION A-A
CLASS "C" CONCRETE
TYPE A STORM SEWER MANHOLE
 FOR PIPE 18" TO 30" IN DIAMETER



MILSAP SEATWALL

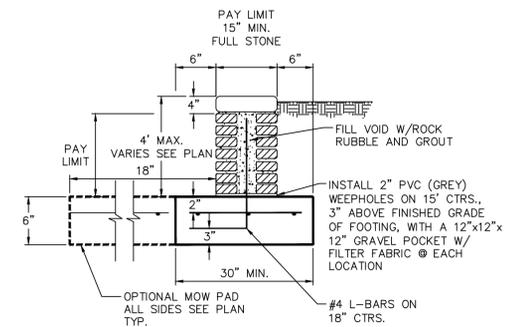


RETAINING WALL SECTION

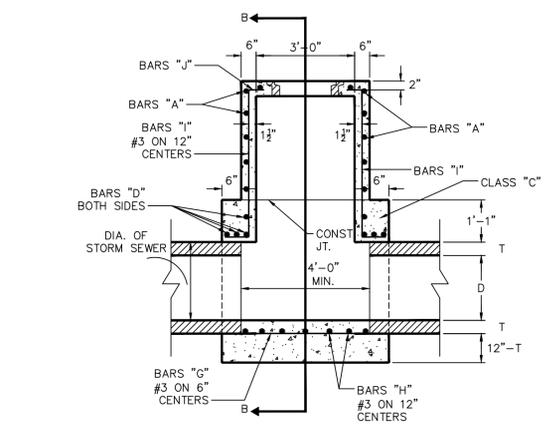


ELEVATION
TYPE B STORM SEWER MANHOLE
 FOR PIPE 33" TO 78" IN DIAMETER

NOTE: FRAME AND COVER SHALL BE BASS & HAYES VRM-30 EQUAL PATTERN AND SHALL BE OF GRAY CAST IRON CONFORMING TO ASTM SPEC. A-40 FOR CLASS 30 CAST IRON. COVER MARKED "CITY OF RICHARDSON STORM SEWER".


BAR	SIZE	SPACING
A	#3	8" ON CENTER
B	#3	12" ON CENTER
C	#3	12" ON CENTER
D	#3	8" ON CENTER
E	#3	12" ON CENTER
F	#5	8" ON CENTER
G	#3	6" ON CENTER
H	#3	12" ON CENTER
I	#3	12" ON CENTER
J	#3	12" ON CENTER
K	#3	12" ON CENTER

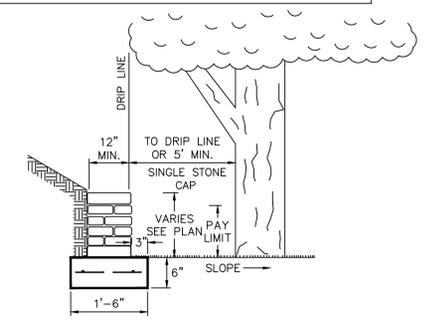


TREE WELL RETAINING WALL

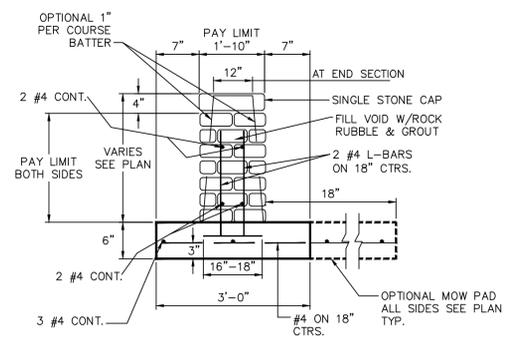

GUARD WALL SECTION

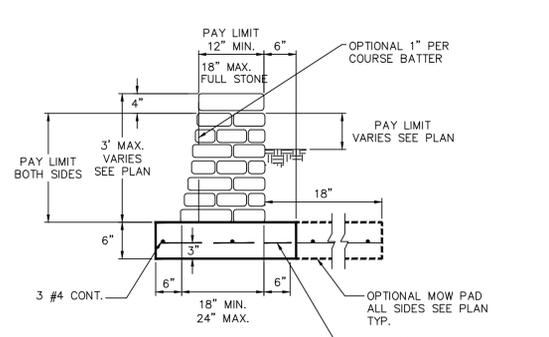


LANDSCAPE WALL SECTION

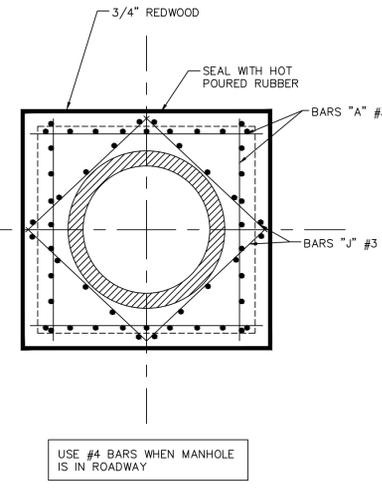


TOP PLAN
TYPE A & TYPE B
STORM SEWER MANHOLE


MAXIMUM PIPE SIZE TO BE USED 78"

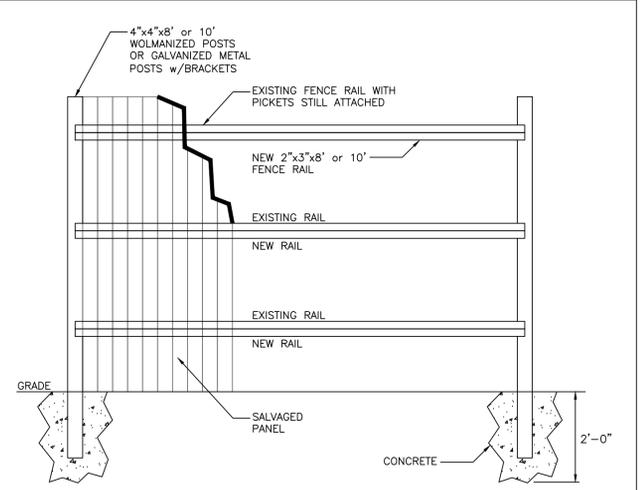

WOODEN FENCE
RELOCATION DETAIL

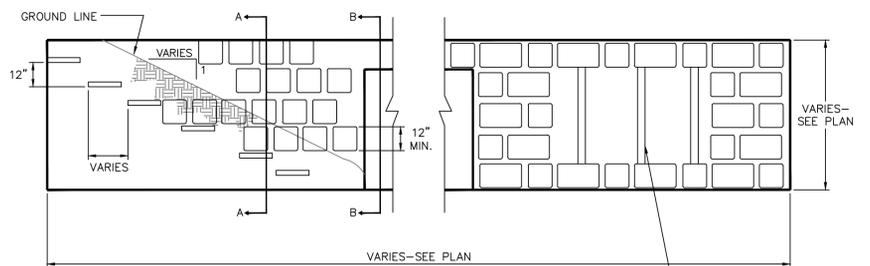

HEADWALL WITH MILSAP STONE FASCIA

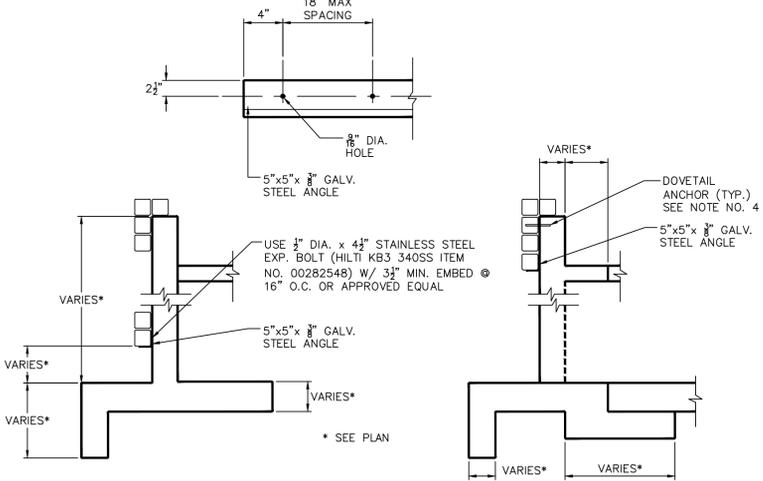

SECTION A-A

SECTION B-B


STONE MASONRY NOTES

- ALL EXPOSED CONCRETE CORNERS SHALL BE CHAMFERED 3/4".
- REINFORCING STEEL SHALL BE PLACED WITH THE OUTSIDE BARS 2" FROM THE SURFACE OF THE CONCRETE, UNLESS NOTED OTHERWISE.
- DOVETAIL SLOTS, WHERE REQUIRED, SHALL BE 20 GAUGE, GALVANIZED. CODE NUMBER DAS-920 MANUFACTURED BY GATEWAY BUILDING PRODUCTS OR ENGINEER APPROVED EQUAL AND SHALL BE SPACED @ 4'-0" O.C. MAX.
- DOVETAIL STONE ANCHORS SHALL BE 1/2"x1 1/2" SPACED AT 1'-0" O.C. THE FULL LENGTH OF SLOT.
- CAPSTONE SHALL BE FULL WIDTH OF WALL (UNLESS OTHERWISE SPECIFIED) AND A MINIMUM OF 1' LONG. CAPSTONE SHALL BE A SEPARATE PAY ITEM.
- FACE OF WALLS SHALL BE PAID FOR IN SQUARE FEET.
- CONCRETE FOOTING SHALL BE A SEPARATE PAY ITEM.
- ALL CONCRETE SHALL BE CLASS "A", UNLESS OTHERWISE NOTED.
- ALL JOINTS SHALL BE 3/4" THICK x 3/4" DEEP RANKED.
- ALL MORTAR SHALL BE TYPE "S".
- LOCATION OF STONEWALLS WILL COMPLY WITH CITY'S SIGHT DISTANCE/HEIGHT REQUIREMENTS.
- IF THE WALL IS WITHIN 10 FT. OF PARKWAY, THE STRUCTURE WILL BE BREAKAWAY.
- CONTRACTOR SHALL PROVIDE A MOCKUP A MINIMUM OF 4' X 4' FOR APPROVAL (NO SEPARATE PAY ITEM)

Revisions:

City of Richardson
 411 W. Arapaho Road
 Suite 204
 Richardson, Texas 75080
 voice: 972 744-4280
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Drawn By: RGB
 Checked By: COR

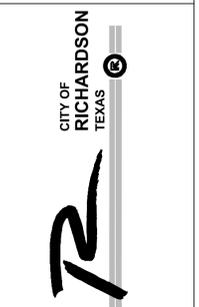

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 City of Richardson, Texas

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Vertical Scale: NA

Project Number: XXX

Issue Date: 01 MAY 14

Sheet Title: **MISC. DETAILS**

Sheet No.:

C-10

NOTES:

- CONSTRUCTION SHALL CONFORM TO THE LATEST EDITION OF THE PUBLIC WORKS CONSTRUCTION STANDARDS, NORTH CENTRAL TEXAS.
- ALL JOINTS SHALL BE CONSIDERED SUBSIDIARY TO ALL PAVING ITEMS.
- FOR PLACING OF CONCRETE PAVEMENT REFER TO ITEM 303.5.5.
- FOR MAXIMUM SLUMP OF CONCRETE FOR PAVEMENT REFER TO ITEM 303.4.4.

PORTLAND CEMENT CONCRETE PAVEMENT

- STANDARD SPECIFICATIONS ITEM 303.2.1.3 - 'COARSE AGGREGATES' SHALL BE AMENDED THE FIRST SENTENCE IS DELETED AND REPLACED AS FOLLOWS "COARSE AGGREGATES SHALL BE 100% CRUSHED STONE"
- STANDARD SPECIFICATIONS ITEM 303 SHALL BE AMENDED AS FOLLOWS:
 - ITEM 303.2.4. FLY ASH IS ALLOWED MAX 20% BY WEIGHT
 - ITEM 303.2.5 SHALL BE DELETED. NO MINERAL FILLER IS ALLOWED
 - ITEM 303.2.6 SHALL BE DELETED. NO FIBROUS REINFORCEMENT ALLOWED

- STANDARD SPECIFICATIONS ITEM 303 SHALL BE AMENDED TO INCLUDE THE FOLLOWING:

- ALL EQUIPMENT NECESSARY TO CONSTRUCT CONCRETE PAVEMENT SHALL BE APPROVED BY THE OWNER PRIOR TO STARTING THE PAVING OPERATION. PAVING EQUIPMENT REQUIREMENTS ARE AS FOLLOWS:

1. **SIDEWALKS LESS THAN 8' IN WIDTH**

NO PAVING MACHINE REQUIRED. STINGER VIBRATORS AND METAL STRAIGHT EDGES SHALL BE USED TO CONSOLIDATE THE CONCRETE.

2. **SIDEWALKS 8' IN WIDTH OR WIDER**

VIBRATING SCREED WITH TWO HAND HELD STINGER VIBRATORS SHALL BE USED TO CONSOLIDATE THE CONCRETE.

B. **CONCRETE FINISH**

SIDEWALK TO BE LIGHT BROOM FINISH.

CONCRETE TEMPERATURES

MAY 1 THROUGH SEPTEMBER 30

- ALL MIXES AND MIX DESIGNS SHALL INCLUDE A RETARDING AGENT.
- CONCRETE TEMPERATURE PRIOR TO PLACEMENT SHALL NOT EXCEED 95°F, (35°C).
- THE TIME INTERVAL (FROM ADDITION OF INITIAL WATER):

AGITATED CONCRETE

90°F OR ABOVE	(32.2°C)	45 MINUTES
75°F TO 89°F	(23.9° TO 31.6°C)	60 MINUTES
35°F TO 74°F	(1.6° TO 23.3°C)	90 MINUTES

NON AGITATED CONCRETE

80°F OR ABOVE	(26.6°C)	15 MINUTES
35°F TO 79°F	(1.6° TO 26.1°C)	30 MINUTES

OCTOBER 1 THROUGH APRIL 30


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AGITATED CONCRETE


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NON AGITATED CONCRETE


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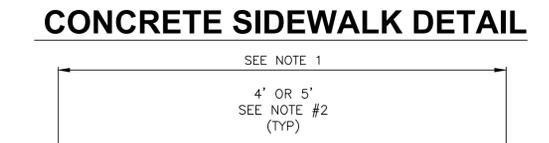
LEAD WALK AT CURB SECTION A-A




- 1/2" EXPANSION JOINTS SHALL BE SPACED AT 30' MAXIMUM INTERVALS, OR AS OTHERWISE SPECIFIED. JOINTS SHALL BE REDWOOD WITH THREE (3) #3 2' SLIP DOWELS WITH END CAPS AT EQUAL SPACING.
- TOOL GROOVE EVERY 5' ON 5' WALKS AND EVERY 4' ON 4' WALKS.
- SIDEWALKS SHALL BE CLASS "A" CONCRETE.
- WHEN CONCRETE WALK IS ADJACENT TO EXISTING CONCRETE, DEPTH OF BITUMINOUS EXPANSION JOINT FILLER SHALL BE SUFFICIENT TO PREVENT CONCRETE TO CONCRETE CONTACT BETWEEN WALK AND CONCRETE. WHEN SIDEWALK IS LOCATED AT THE BACK OF CURB THE NO. 3 REBAR AT 24" O.C. FOR THE SIDEWALK SHOULD EXTEND TO A DEPTH OF APPROXIMATELY 3" INTO THE BACK OF THE CURB AND SHOULD BE ANCHORED IN PLACE WITH EPOXY RESIN.
- SIDEWALK SUBGRADE SHALL BE COMPACTED TO MINIMUM 95% STANDARD PROCTOR DENSITY.
- A MAXIMUM OF 1" OF SAND MAY BE USED FOR LEVEL UP ONLY.
- NO "WHIRLEY BIRD" TYPE FINISHING MACHINES WILL BE ALLOWED.
- EPOXY DOWELS IN PLACE. DRILLED HOLE SHALL BE 1/8" LARGER THAN DOWEL. USE MECHANICAL DRILL AND INSTALL DOWELS HORIZONTAL INTO EXISTING PAVEMENT. CLEAN AND DRY DRILL HOLES PRIOR TO APPLYING EPOXY.

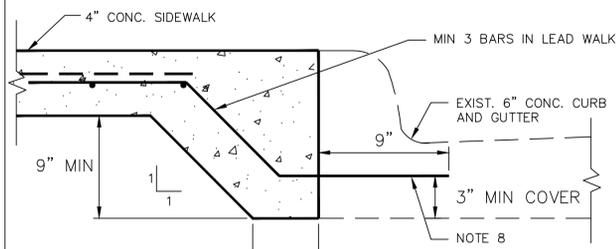

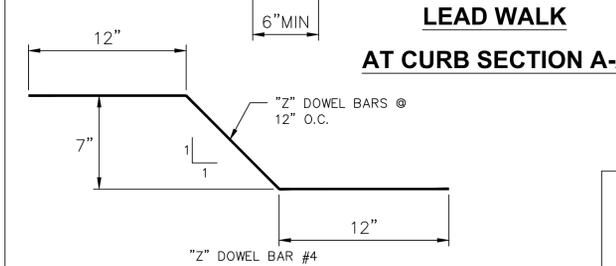
LEAD WALK REPLACEMENT PLAN

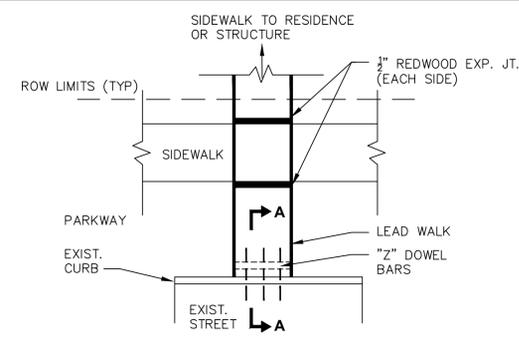

CONCRETE SIDEWALK DETAIL SIDE ELEVATION

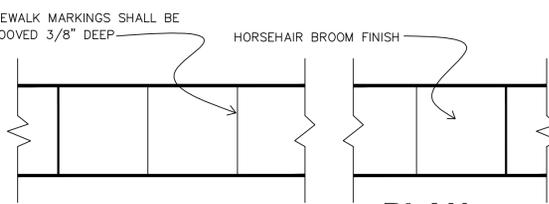

CONCRETE SIDEWALK DETAIL PLAN

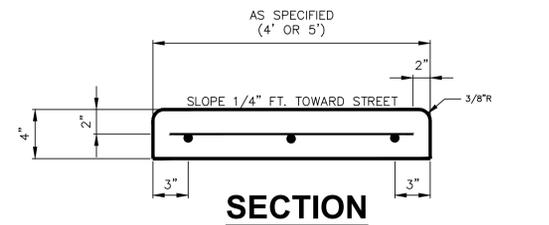


CONCRETE SIDEWALK DETAIL SECTION


SEE SHEET C-12 FOR BARRIER FREE RAMP DETAILS

CONCRETE SIDEWALK DETAIL FOR SIDEWALKS 8' OR WIDER


- 1/2" EXPANSION JOINTS SHALL BE SPACED AT 60' MAXIMUM INTERVALS, OR AS OTHERWISE SPECIFIED. JOINTS SHALL BE REDWOOD WITH FIVE (5) #3 2' SLIP DOWELS WITH END CAPS AT EQUAL SPACING.
- TOOL GROOVE EVERY 8' ON 8' WALKS.
- SIDEWALKS SHALL BE CLASS "A" CONCRETE.
- WHEN CONCRETE WALK IS ADJACENT TO EXISTING CONCRETE, DEPTH OF BITUMINOUS EXPANSION JOINT FILLER SHALL BE SUFFICIENT TO PREVENT CONCRETE TO CONCRETE CONTACT BETWEEN WALK AND CONCRETE. WHEN SIDEWALK IS LOCATED AT THE BACK OF CURB THE NO. 3 REBAR AT 24" O.C. FOR THE SIDEWALK SHOULD EXTEND TO A DEPTH OF APPROXIMATELY 3" INTO THE BACK OF THE CURB AND SHOULD BE ANCHORED IN PLACE WITH EPOXY RESIN.
- SIDEWALK SUBGRADE SHALL BE COMPACTED TO MINIMUM 95% STANDARD PROCTOR DENSITY.
- A MAXIMUM OF 1" OF SAND MAY BE USED FOR LEVEL UP ONLY.
- NO "WHIRLEY BIRD" TYPE FINISHING MACHINES WILL BE ALLOWED.
- SEAL ALL JOINTS WITH GRAY RUBBERIZED SEALANT.

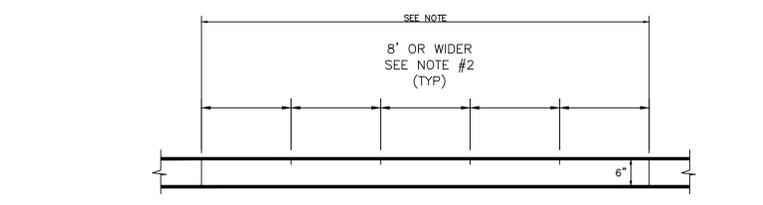

CONCRETE SIDEWALK DETAIL FOR SIDEWALKS 8' OR WIDER SIDE ELEVATION


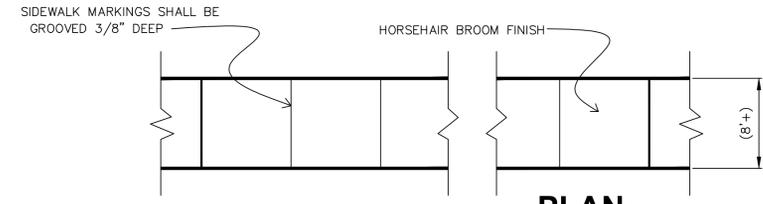


CONCRETE SIDEWALK DETAIL FOR SIDEWALKS 8' OR WIDER PLAN

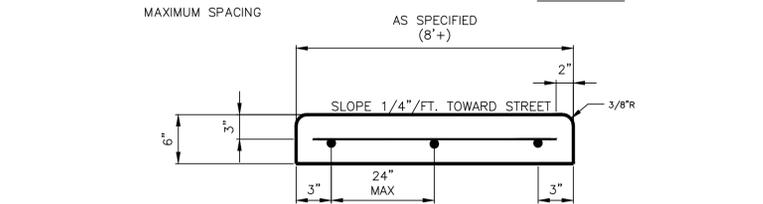


CONCRETE SIDEWALK DETAIL FOR SIDEWALKS 8' OR WIDER SECTION

FLUME DETAIL (FOR POSITIVE OVERFLOW)

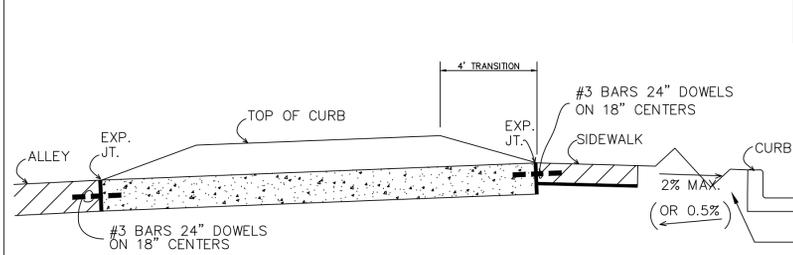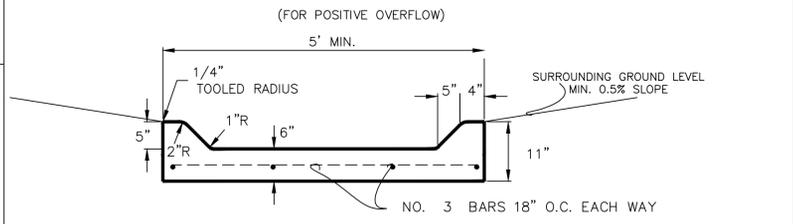

- FLUMES LOCATED BETWEEN RESIDENTIAL LOTS SHALL TIE TO ALLEY AND SIDEWALK.
- FLUMES SHALL BE CLASS "A" CONCRETE WITH EXPOSED AGGREGATE FINISH (1" - #4 LATTIMORE RIVER GRAVEL OR EQUAL).
- 1/2" EXPANSION JOINTS SHALL BE SPACED 40' MAX. INTERVALS, OR AS SPECIFIED AND JOINTS SHALL BE REDWOOD WITH THREE (3) #3 2' SLIP DOWELS WITH THE END CAPS AT EQUAL SPACING AND SEALED.
- FLUME AND SIDEWALK SUBGRADE SHALL BE COMPACTED TO 95% STANDARD PROCTOR DENSITY.
- 1/4" SAW JOINTS SHALL BE SPACED AT 20' MAX. INTERVALS.
- AN 8' LONG SECTION OF 4' (OR 5') WIDE SIDEWALK WILL BE CONSTRUCTED, AND CONNECTED, WITH THE FLUME THE SIDEWALK WILL HAVE A STANDARD SIDEWALK FINISH (NOT EXPOSED AGGREGATE).
- FLUMES ARE TO BE CONSTRUCTED TO PROVIDE POSITIVE OVERFLOW DRAINAGE ACCORDING TO THE FOLLOWING:
 - LOW POINT INLET IN STREET: FLUME TO SLOPE FROM STREET TO ALLEY.
 - LOW POINT INLET IN ALLEY: FLUME TO SLOPE FROM ALLEY TO STREET.
- MINIMUM SLOPE OF FLUME TO BE 0.5% (REFER TO DRAINAGE PLAN).
- WHERE INLETS ARE CLOSER THAN 6 INCHES FROM SIDEWALK, THE SIDEWALK SHOULD BE WIDENED TO ABUT AGAINST THE INLET.

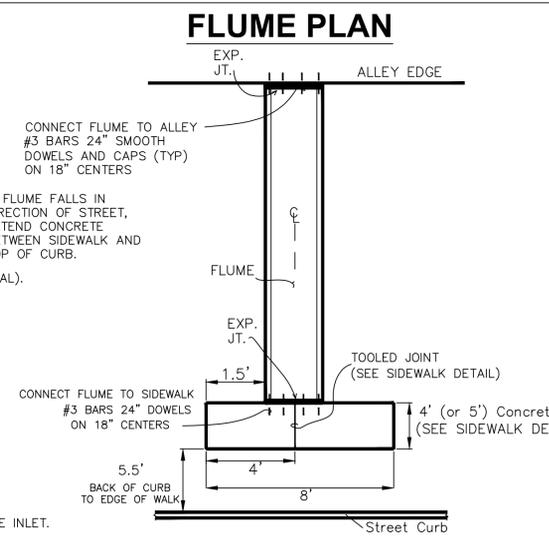


FLUME PLAN

Revisions:

City of Richardson
411 W. Arapaho Road
Suite 204
Richardson, Texas 75080
voice: 972 744-4280
fax: 972 744-5804

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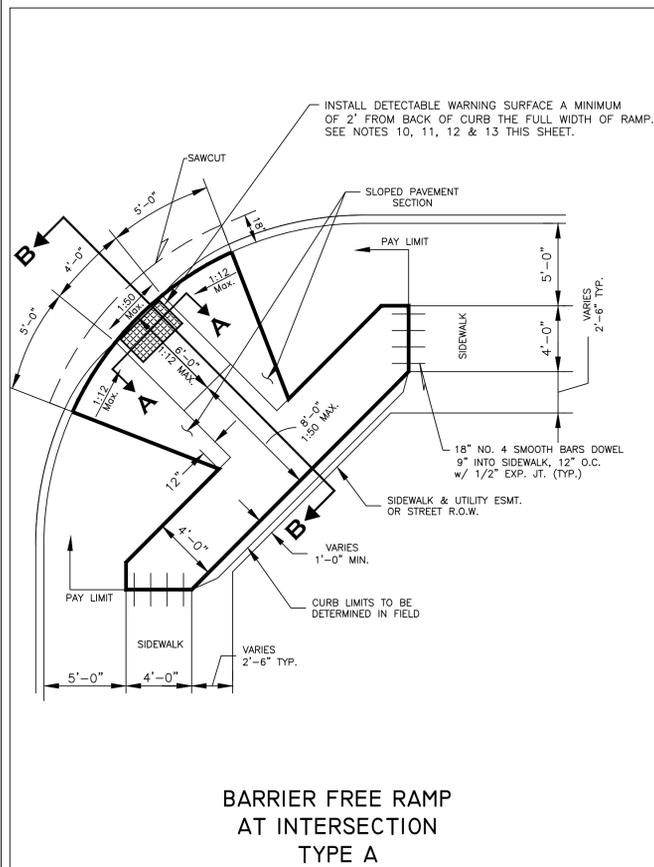
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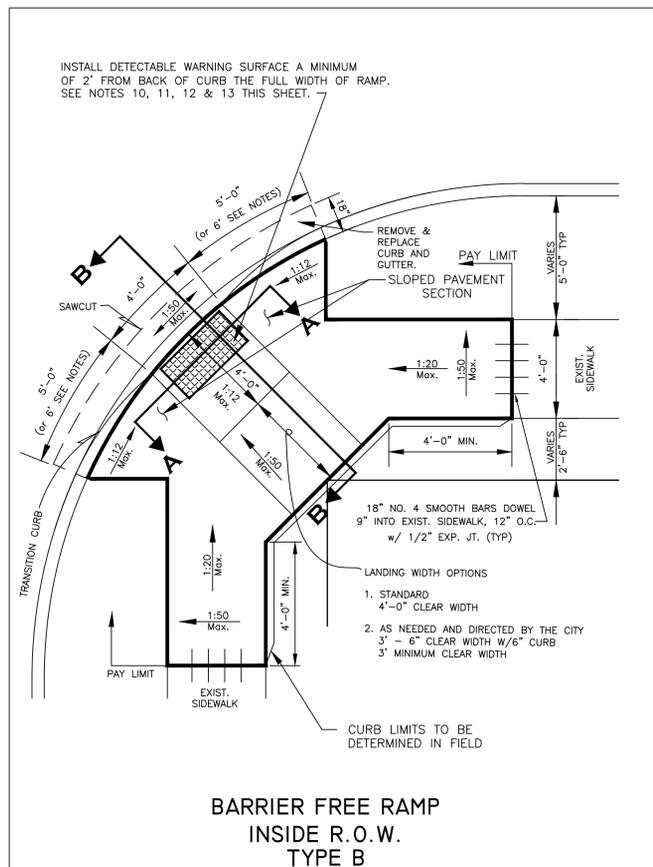
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Project Number: XXX
Issue Date: 06 MAR 15
Sheet Title: **SIDEWALK/ FLUME**

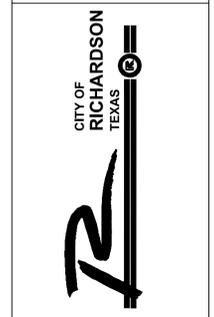Sheet No.: **C-11**


Revisions:




BARRIER FREE RAMP AT INTERSECTION TYPE A




BARRIER FREE RAMP INSIDE R.O.W. TYPE B

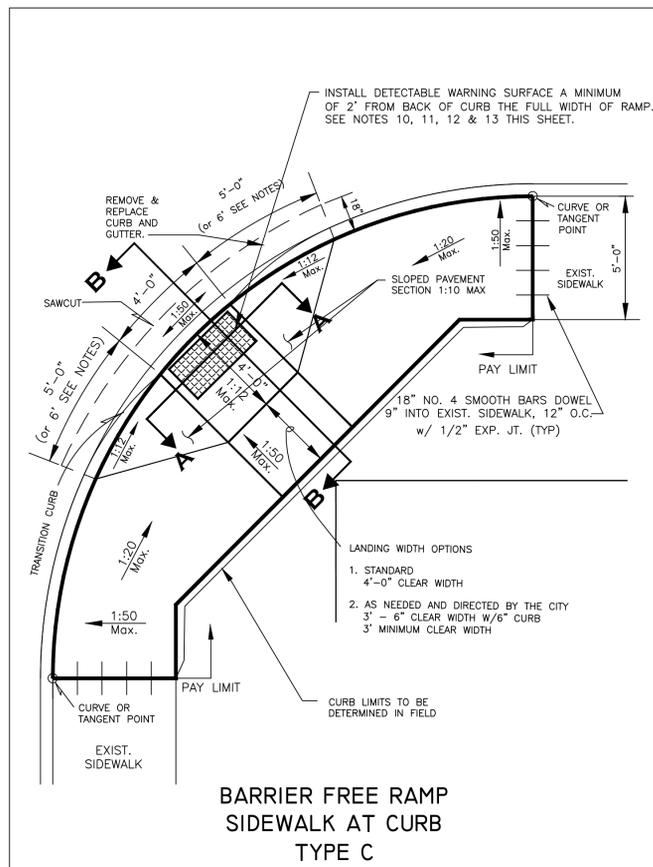


BARRIER FREE RAMP SIDEWALK AT CURB TYPE C

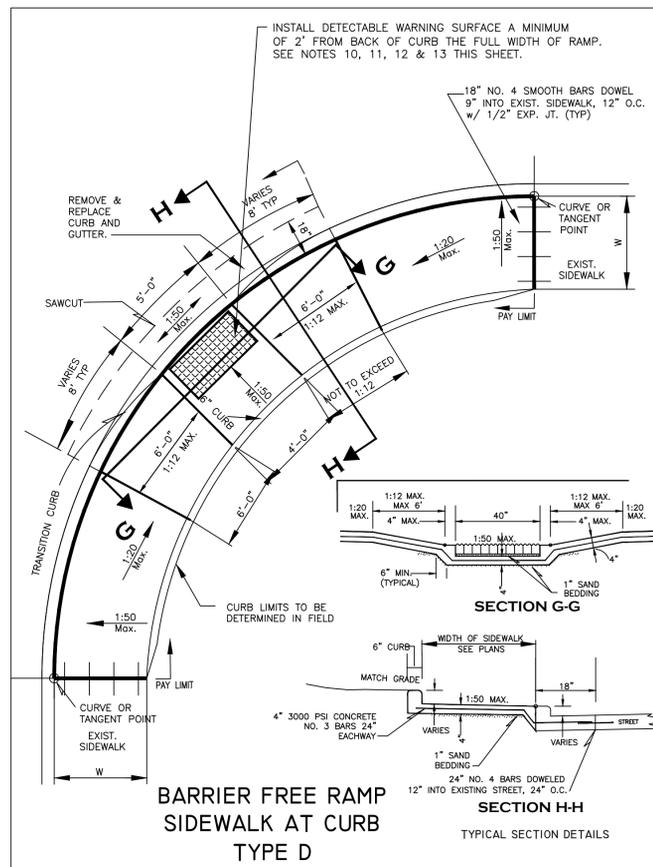

BARRIER FREE RAMP SIDEWALK AT CURB TYPE D

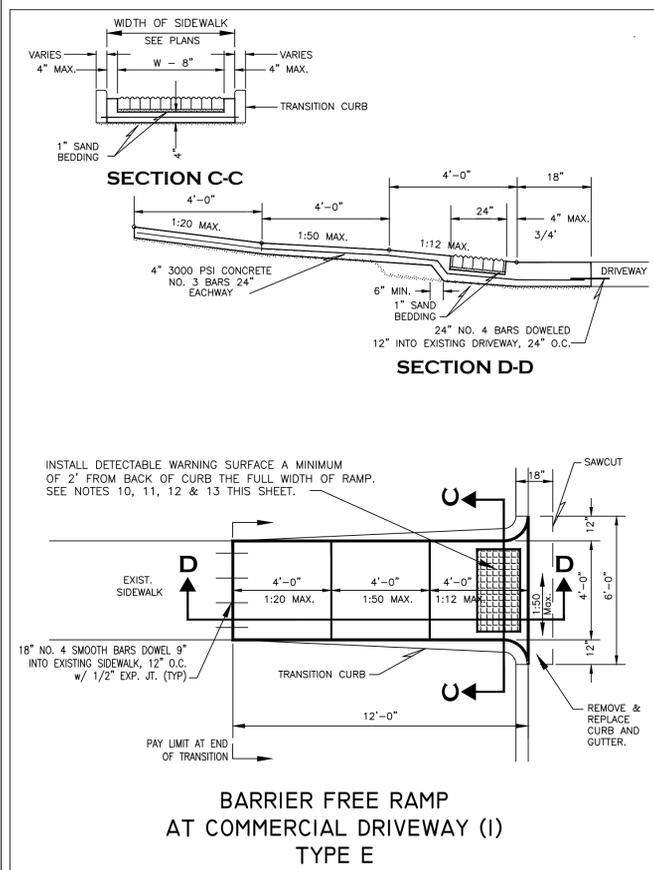

BARRIER FREE RAMP AT COMMERCIAL DRIVEWAY TYPE E

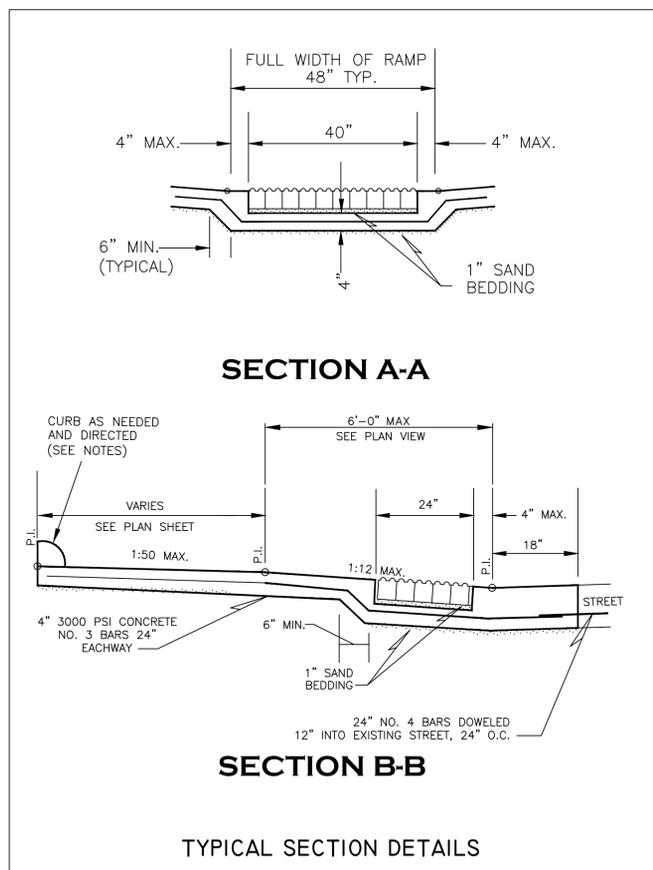

TYPICAL SECTION DETAILS

NOTES:

- DIMENSIONS SHOWN ON STANDARD DETAILS ARE APPROXIMATE AND WILL VARY DEPENDING ON EXISTING SIDEWALK AND STREET LONGITUDINAL AND CROSS SLOPES. DIMENSIONS SHOWN ASSUME EXISTING LONGITUDINAL AND CROSS SLOPES ARE LESS THAN 2%. RAMP LOCATIONS WITH LONGITUDINAL OR CROSS SLOPES EXCEEDING 2% SHOULD BE ADDRESSED BY SEPARATE DESIGN DETAILS THAT COMPLY WITH TEXAS ACCESSIBILITY STANDARDS AND MATCH CITY OF RICHARDSON STANDARD DETAILS IN APPEARANCE AS MUCH AS POSSIBLE.
- RAMPS FOR SIDEWALKS (WITH WIDTHS OTHER THAN SHOWN ON THESE DETAILS) SHOULD BE ADJUSTED TO FIT DIMENSIONS OF THE APPROACH SIDEWALKS CALLED FOR ON PLAN SHEETS.
- FULL LENGTH OF RAMP (SLOPE OF 1:12) NOT TO EXCEED 6' IN LENGTH.
- PAYMENT FOR INSTALLATION OF BARRIER FREE RAMP SHALL INCLUDE SAWCUT, REMOVAL AND DISPOSAL OF EXISTING CURB AND GUTTER, SIDEWALK, ALL EXCAVATION NECESSARY TO CONSTRUCT RAMPS PER CITY STANDARDS, INCLUDING ALL LABOR, MATERIAL AND OTHER MISCELLANEOUS APPERTANCES.
- THE CONTRACTOR MUST NOTIFY THE CITY PRIOR TO INSTALLATION OF CONCRETE IF THE APPROACH SLOPE OF THE EXISTING SIDEWALK EXCEEDS 1:20 (5%) OR HAS A CROSSFALL GREATER THAN 1:50 (2%) AND NO DESIGN DETAILS ARE PROVIDED FOR THAT SPECIFIC LOCATION.
- CONTRACTOR TO VERIFY ALL SLOPES PRIOR TO POURING CONCRETE. ALL SLOPES SHOULD BE IN COMPLIANCE WITH APPLICABLE STANDARDS FROM THE TEXAS DEPARTMENT OF LICENSING AND REGULATION.
- MINIMUM LANDING CLEAR WIDTH TO BE 48", UNLESS OTHERWISE DIRECTED BY THE CITY. WHEN LANDING IS LESS THAN 48" CLEAR WIDTH THE STREET CURB TRANSITION TO BE INCREASED FROM 5' TO 6' IN LENGTH.
- IT SHALL BE THE CONTRACTORS RESPONSIBILITY TO INSURE SLOPES MEET REQUIREMENTS OF THE TEXAS ACCESSIBILITY STANDARDS.
- A CURB SHALL BE CONSTRUCTED AT THE BACK OF THE WHEELCHAIR RAMP WHEN ELEVATION DIFFERENCE EXCEEDS 8".
- DETECTABLE WARNING SHALL BE 24" IN LENGTH THE FULL WIDTH OF RAMP AT BACK OF CURB (LESS 4" BORDER FOR BRICK PAVERS) AND BE AS SPECIFIED EXCEPT AT INTERSECTIONS WHERE EXISTING RAMPS ON ADJACENT CORNERS PROVIDE DETECTABLE WARNING FOR THE FULL LENGTH AND WIDTH OF RAMP. WHERE EXISTING RAMPS ON ADJACENT CORNERS PROVIDE DETECTABLE WARNING FOR THE FULL LENGTH AND WIDTH OF RAMP THE RAMPS SHALL BE MADE TO MATCH ADJACENT RAMPS IN COMPLIANCE WITH TEXAS ACCESSIBILITY STANDARDS.
- BRICK PAVERS SHALL BE 7 3/8" x 3 1/8" x 2 3/8" WITH "CHARCOAL" COLOR MEETING ADA SECTION 4.29.2 (PAVESTONE DETECTABLE WARNING PAVES OR APPROVAL EQUAL). PAVERS SHALL HAVE DETECTABLE WARNING THAT CONSIST OF RAISED TRUNCATED DOMES WITH A DIA. OF 0.9 IN. (23MM), A HEIGHT OF NOMINAL 0.2 IN. (5MM) AND A CENTER TO CENTER SPACING OF NOMINAL 2.35 IN. (60MM). PAVERS SHALL BE SAWED (NOT BROKEN)
- A VIBRATORY PLATE SHALL BE USED TO CONSOLIDATE PAVERS AFTER INSTALLATION. CONTRACTOR SHALL PREVENT DAMAGE TO PAVERS FROM VIBRATORY PLATE BY COVERING PAVERS WITH PLYWOOD, OR OTHER METHOD APPROVED BY THE CITY. ANY DAMAGE PAVERS WILL BE REPLACED AT THE CONTRACTOR'S EXPENSE
- ADA REPLACEABLE (WET SET) COMPOSITE TACTILE WARNING SURFACE UNIT (GRAY) AVAILABLE FROM ADA SOLUTIONS MAY BE INSTALLED INSTEAD OF SPECIFIED TRUNCATED DOME BRICK PAVERS. CONTRACTOR SHALL PROVIDE A MINIMUM 4" CONCRETE THICKNESS BENEATH THE ADA REPLACEABLE COMPOSITE TACTILE WARNING SURFACE UNIT. THE TYPICAL BOX LEAVE OUT AND DEEPER CONCRETE SECTION FOR PAVERS SHOWN IN DETAILS IS NOT REQUIRED.

CONVERSIONS
 1:12 - APPROXIMATELY 8.3%
 1:20 - APPROXIMATELY 5%
 1:50 - APPROXIMATELY 1/4" per 1' or 2%

City of Richardson
 411 W. Arapaho Road
 Suite 204
 Richardson, Texas 75080
 voice: 972 744-4280
 fax: 972 744-5804

Drawn By: RGB
 Checked By: COR



STANDARD DETAILS
 City of Richardson, Texas

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11"x17" Scale: NTS

Vertical Scale: NA


Project Number: XXX

Issue Date: 01 MAY 14

Sheet Title:
BARRIER FREE RAMPS



Sheet No.:

C-12

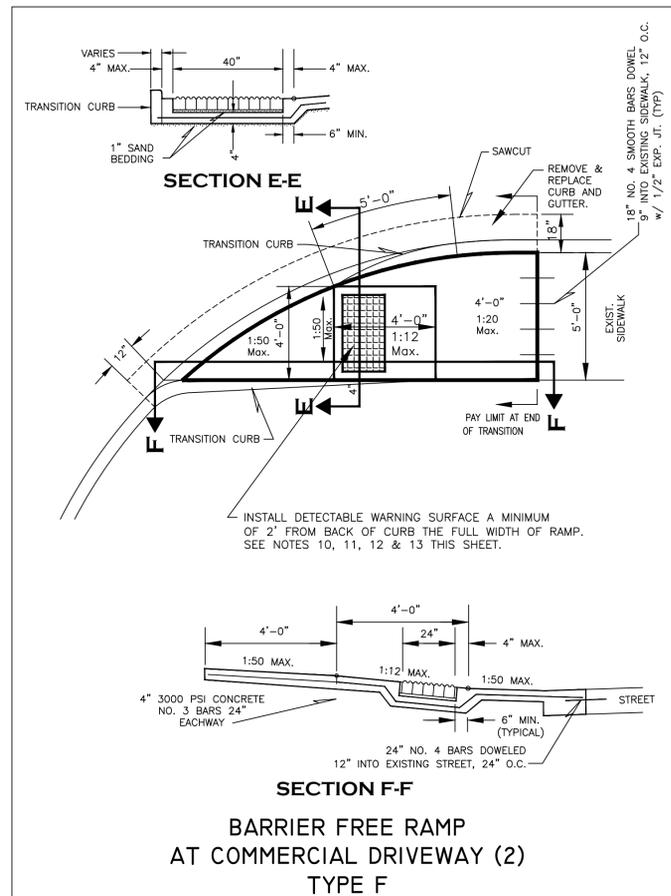

- NOTES:**
- DIMENSIONS SHOWN ON STANDARD DETAILS ARE APPROXIMATE AND WILL VARY DEPENDING ON EXISTING SIDEWALK AND STREET LONGITUDINAL AND CROSS SLOPES. DIMENSIONS SHOWN ASSUME EXISTING LONGITUDINAL AND CROSS SLOPES ARE LESS THAN 2%. RAMP LOCATIONS WITH LONGITUDINAL OR CROSS SLOPES EXCEEDING 2% SHOULD BE ADDRESSED BY SEPARATE DESIGN DETAILS THAT COMPLY WITH TEXAS ACCESSIBILITY STANDARDS AND MATCH CITY OF RICHARDSON STANDARD DETAILS IN APPEARANCE AS MUCH AS POSSIBLE.
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 - PAYMENT FOR INSTALLATION OF BARRIER FREE RAMP SHALL INCLUDE SAWCUT, REMOVAL AND DISPOSAL OF EXISTING CURB AND GUTTER, ALL EXCAVATION NECESSARY TO CONSTRUCT RAMPS PER CITY STANDARDS, INCLUDING ALL LABOR, MATERIAL AND OTHER MISCELLANEOUS APPURTENANCES.
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CONVERSIONS
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CITY OF RICHARDSON TEXAS

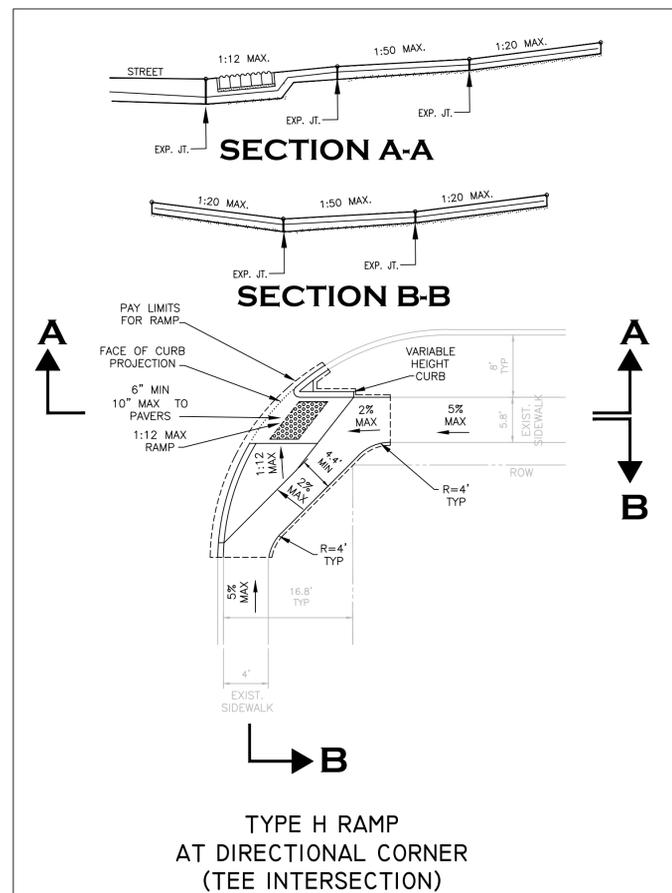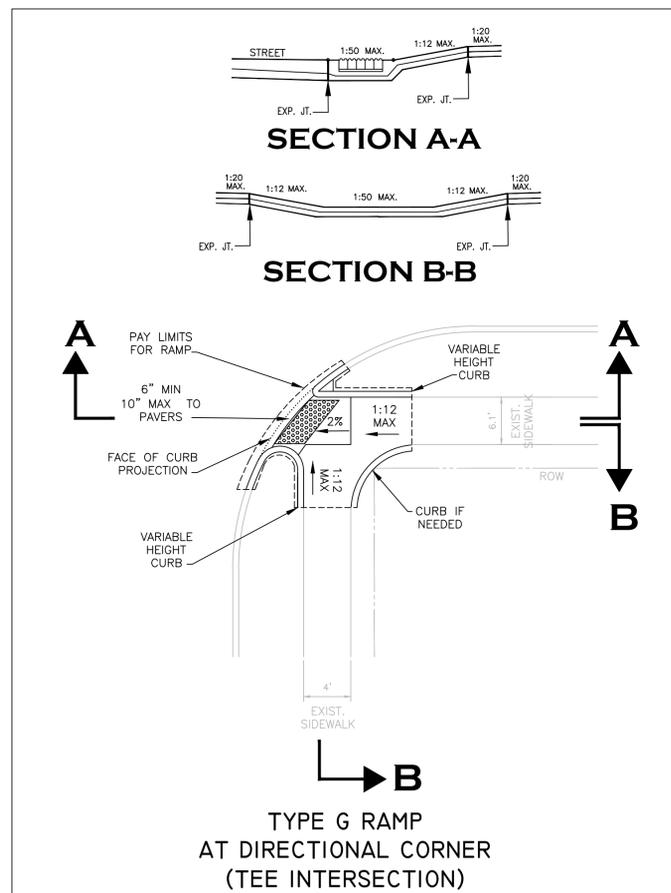

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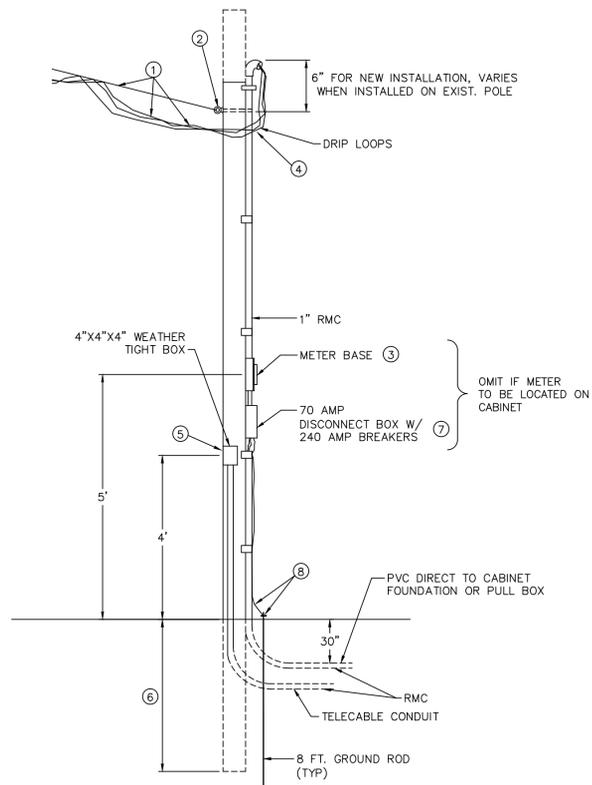
Issue Date: 01 MAY 14

Sheet Title:

BARRIER FREE RAMPS

Sheet No.:


C-13




NOTES:

- SERVICE DROP PROVIDED AND INSTALLED BY POWER COMPANY.
- SERVICE ATTACHMENT PROVIDED BY POWER COMPANY AND INSTALLED BY CONTRACTOR.
- METER SOCKET PROVIDED BY POWER COMPANY AND INSTALLED BY CONTRACTOR.
- SERVICE ENTRANCE CONDUCTOR AND SERVICE RACEWAY PROVIDED AND INSTALLED BY CONTRACTOR. CONDUCTORS TO EXTEND 24" MIN. OUTSIDE SERVICE HEAD FOR CONNECTION TO SERVICE DROP. MINIMUM #6 COPPER CONDUCTOR TO BE NEC APPROVED PHASE CONDUCTORS BLACK INSULATION NEUTRAL CONDUCTORS WHITE OR BARE.
- CONTRACTOR TO PROVIDE AND INSTALL SUPPORT FOR SERVICE ATTACHMENT AND METER SOCKET. CREOSOTE POLE (OR EQUAL) TO BE 5" MIN. DIA. AT TOP. STEEL POLE TO BE 4" MIN. OUTSIDE DIAMETER. SUPPORT TO BE SUFFICIENT HEIGHT FOR THE SERVICE DROP TO MEET MIN. CLEARANCES.
- POLE TO BE SET IN 4 FEET OF TAMPED EARTH OR CONCRETE WHERE SOIL CONDITIONS WARRANT. PIPE TO BE SET IN 4 FEET OF CONCRETE.
- WEATHERPROOF SERVICE SWITCH TO BE PROVIDED AND INSTALLED BY CONTRACTOR.
- CONTRACTOR'S GROUND CONDUCTOR #6 COPPER MINIMUM TO APPROVED ELECTRODE.
- CONTRACTOR INSTALLATION TO MEET ALL REQUIREMENTS OF NATIONAL ELECTRICAL CODE AND LOCAL ORDINANCES.


ELECTRIC SERVICE TO TYPICAL PERMANENT METER POLE INSTALLATION

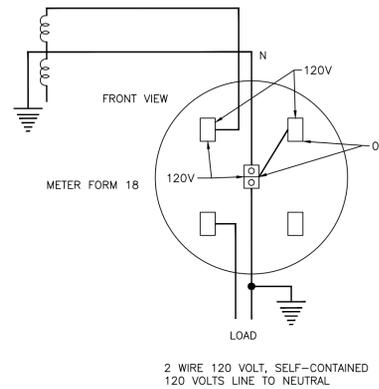

METER SOCKET CONNECTIONS AND VOLTAGES 4-TERMINAL SOCKET

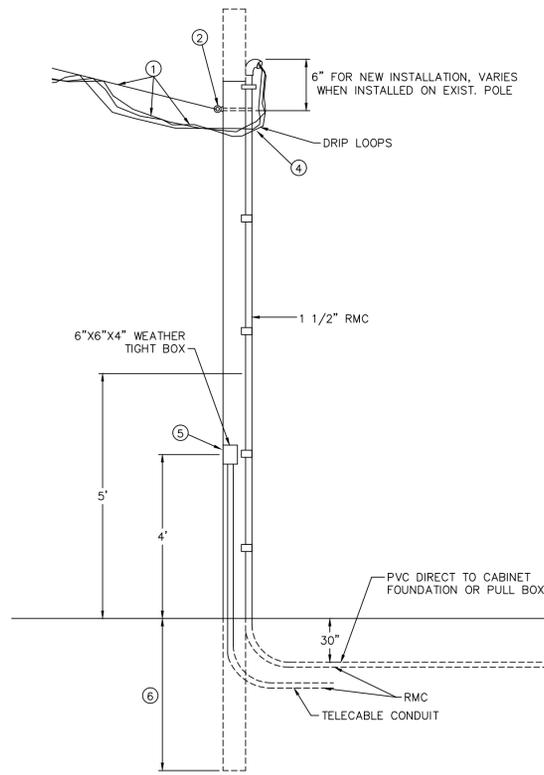

ELECTRIC SERVICE TO TYPICAL PERMANENT PEDESTAL INSTALLATION

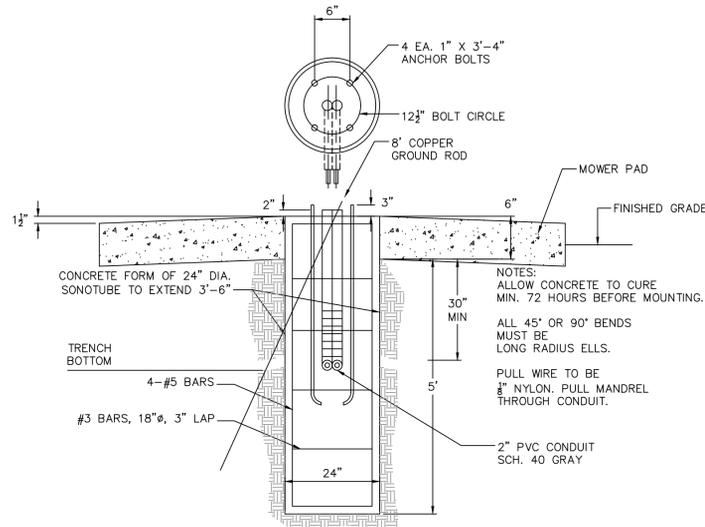


CITY OF RICHARDSON STREET LIGHT FOUNDATION 40' SQUARE STEEL POLE C.O.R.

STREET LIGHT FOUNDATION NOTES


- CONDUIT, TRENCHES AND BASES MUST BE INSPECTED BY C.O.R. DISTRIBUTION DEPT. BEFORE ANY BACK-FILLING OR CONCRETE WORK IS DONE. FAILURE TO HAVE INSPECTION WILL RESULT IN REMOVAL OF WORK. CALL 881-5400 FOR INSPECTION.
- ANCHOR BOLTS WILL BE FURNISHED BY CITY OF RICHARDSON.
- PROVIDE AN 8 FT. LONG GROUND ROD FOR CONNECTION OF WIRE TO POLE.
- MOWER PAD IS REQUIRED ONLY WHEN STREET LIGHTS ARE LOCATED IN GRASS AREA. PAD WILL BE SUBSIDIARY TO STREET LIGHT FOUNDATION.
- ON PAVED MEDIANS, FOUNDATION SHALL BE FLUSH WITH HIGHEST CURB.

ONCOR/TXU STREET LIGHT FOUNDATION 25', 30' & 40' SQUARE STEEL POLE 40' M.H. ROUND STEEL POLE

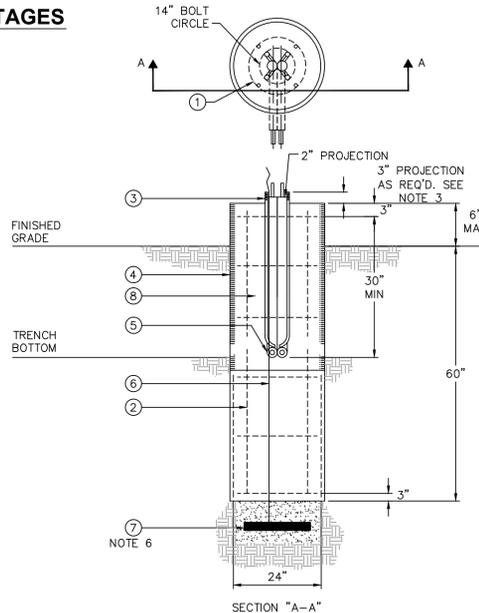

ITEM	QTY	DESCRIPTION	TSN	AUN	MACRO AUN
1	6	#3 REBAR 18" DIA. HOOP. 3 IN. OVERLAP	314470		
2	4	#6 REBAR STRAIGHT. 50 IN. LONG	317821		
3	4	ANCHOR BOLT, GALV 1 IN. (SUPPLIED W/POLE)			
4	AS REQ'D	CONCRETE FOUNDATION TUBE 24 IN. DIA.	313841	SLF01	21332001
5	AS REQ'D	CONDUIT PVC OR PEC (NOT IN FOUND. AUN)			
6	.5 LB	WIRE #6 COPPER SOLID	310091		
7	1	GROUND, POLE BUTT WIRE COIL			
8	AS REQ'D	CONCRETE			


* 1 1/4" ANCHOR BOLT REQ'D. W/40' POLE

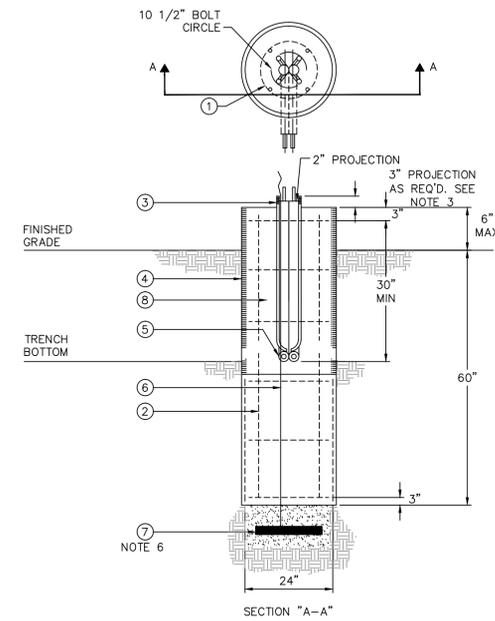

ONCOR/TXU STREET LIGHT FOUNDATION 25' M.H. & 30' M.H. ROUND STEEL POLE

NOTES:

- CONCRETE TO BE MINIMUM 3000 PSI AT 28 DAYS. (6 SACK) MAXIMUM AGGREGATE 3". TOP OF FOUNDATION TO BE TROWELED TO A FLAT AND LEVEL SURFACE. AVOID EXCESSIVE TROWELING. CONCRETE TO SET A MINIMUM OF 72 HOURS BEFORE POLE INSTALLATION.
- REBAR HOOPS ARE TIED BEGINNING 3" BELOW TOP OF CONCRETE FORM AND ARE REPEATED AT APPROXIMATE 1 FT. INTERVALS TO BOTTOM OF FOUNDATION.
- CONTRACTOR TO PROVIDE ANCHOR BOLTS. ANCHOR BOLTS ARE NOT SUPPLIED WITH POLE. USE TEMPLATE FURNISHED BY POLE MANUFACTURER FOR ALIGNING ANCHOR BOLTS. PROJECTION OF 3 IN. ON 25' & 30 FT. SQUARE AND 3 1/2 IN. ON 40 FT. SQUARE AND 37 FT. ROUND POLES.
- CONCRETE FORM OF SONOTUBE TO EXTEND TO BOTTOM OF TRENCH OR AS NEEDED.
- PROVIDE 24" PIGTAIL FOR CONNECTION OF GROUND WIRE TO POLE.
- A MINIMUM OF 12' OF BARE #6 SD CU WIRE TO BE PLACED IN BOTTOM OF HOLE AND COVERED WITH 2" OF DIRT.
- IF SOIL HAS BEEN DISTURBED, EXTEND FOUNDATION BY DEPTH OF DISTURBED SOIL.
- MOWER PAD IS REQUIRED ONLY WHEN STREET LIGHTS ARE LOCATED IN GRASS AREA. PAD WILL BE SUBSIDIARY TO STREET LIGHT FOUNDATION.

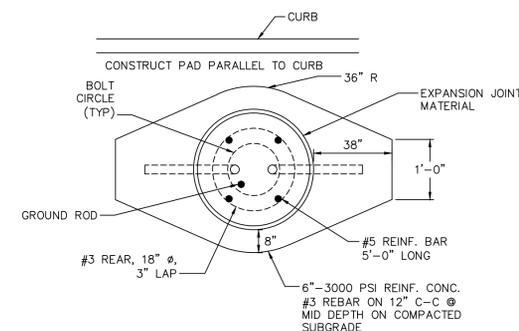

MOWER PAD

ITEM	QTY	DESCRIPTION	TSN	AUN	MACRO AUN
1	6	#3 REBAR 18" DIA. HOOP. 3 IN. OVERLAP	314470		
2	4	#6 REBAR STRAIGHT. 50 IN. LONG	317821		
3	4	ANCHOR BOLT, GALV 1 IN. (SUPPLIED W/POLE)			
4	AS REQ'D	CONCRETE FOUNDATION TUBE 24 IN. DIA.	313841	SLF01	21332001
5	AS REQ'D	CONDUIT PVC OR PEC (NOT IN FOUND. AUN)			
6	.5 LB	WIRE #6 COPPER SOLID	310091		
7	1	GROUND, POLE BUTT WIRE COIL			
8	AS REQ'D	CONCRETE			

APPROVED BY TXU ELECTRIC

Revisions:

City of Richardson
411 W. Arapaho Road
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voice: 972 744-4280
fax: 972 744-5804

Drawn By: RGB
Checked By: COR

CITY OF RICHARDSON TEXAS



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City of Richardson, Texas

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Vertical Scale: NA

Project Number: XXX


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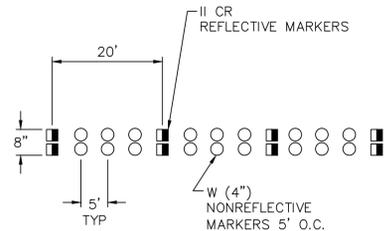
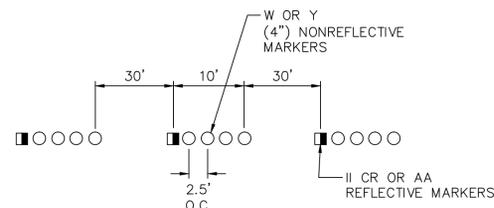
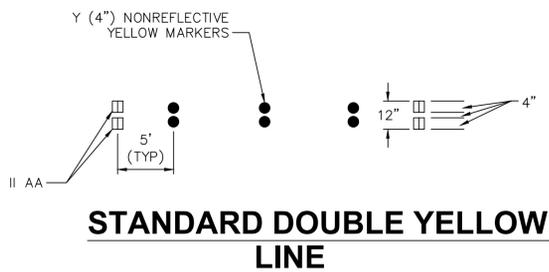
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Sheet No.:

T-1






**CITY OF RICHARDSON
RAISED MARKINGS STANDARD DETAIL**

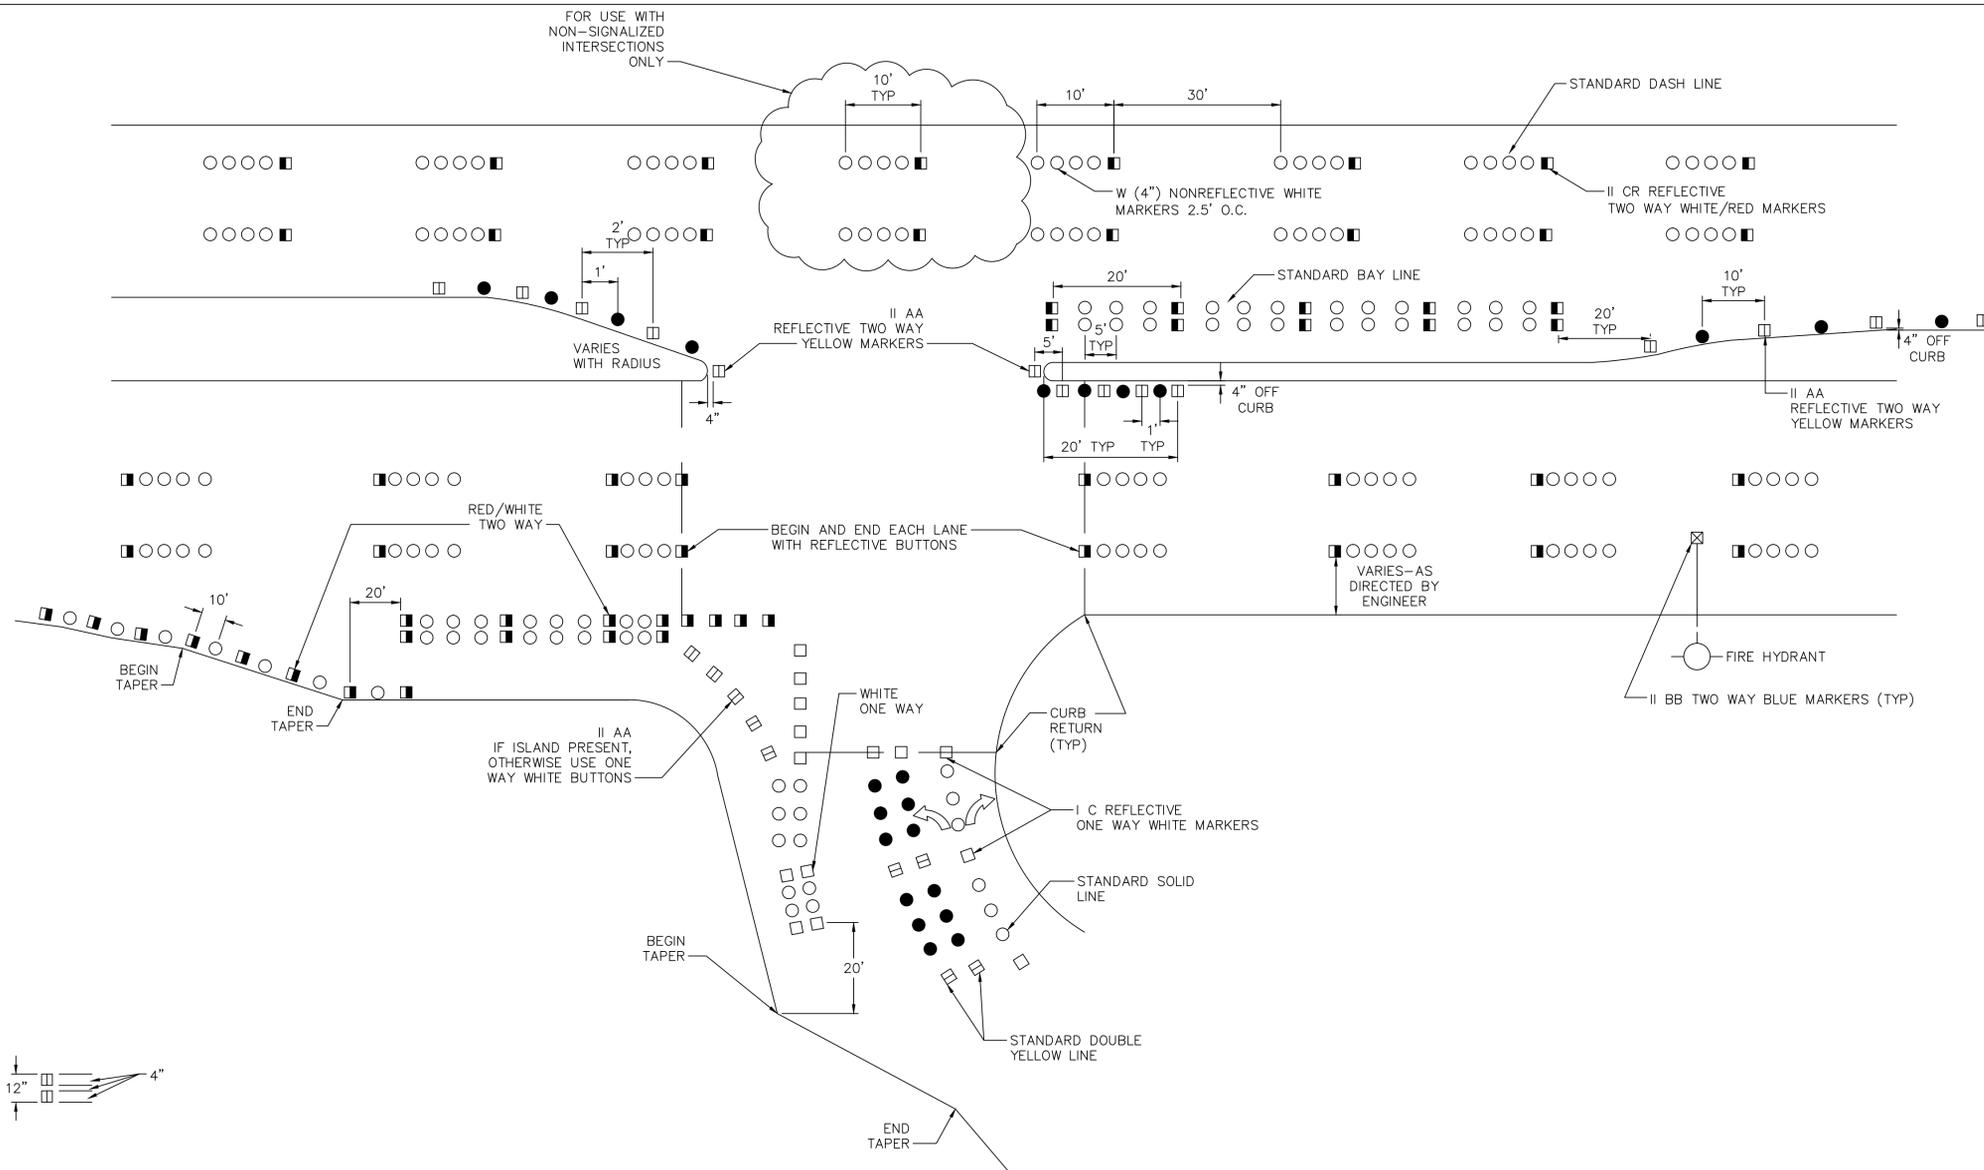

- LEGEND
- II CR (4" SQUARE) TWO WAY REFLECTIVE RED/WHITE MARKER
 - II AA (4" SQUARE) TWO WAY REFLECTIVE YELLOW MARKER
 - ⊠ II BB (4" SQUARE) TWO WAY REFLECTIVE BLUE MARKER
 - I C (4" SQUARE) ONE WAY REFLECTIVE WHITE MARKER
 - W (4" ROUND) NON REFLECTIVE WHITE MARKER
 - Y (4" ROUND) NON REFLECTIVE YELLOW MARKER

C.O.R. WILL PROVIDE INITIAL DETAIL ASSISTANCE IN PAVING MARKING LAYOUT (AS REQUIRED)

MATERIALS AS PER COR SPECIFICATIONS OR AS DIRECTED BY THE ENGINEER.

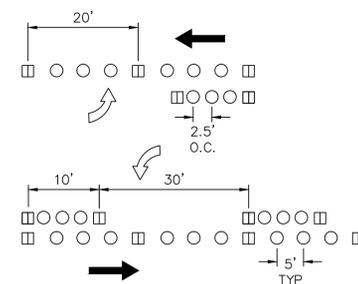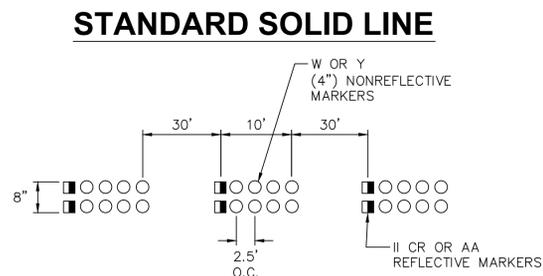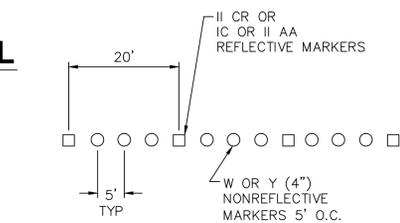

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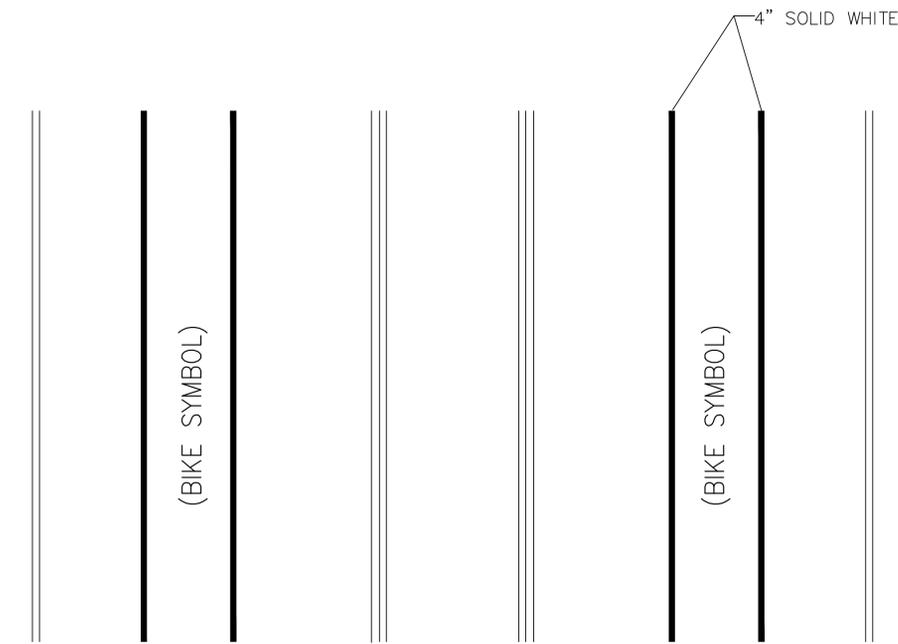
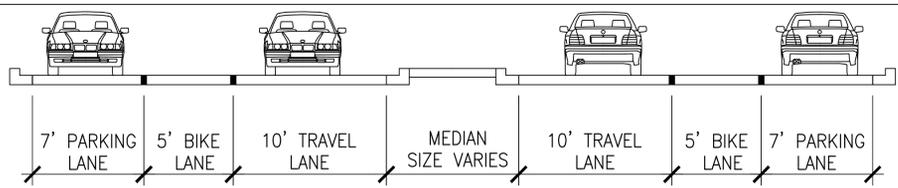
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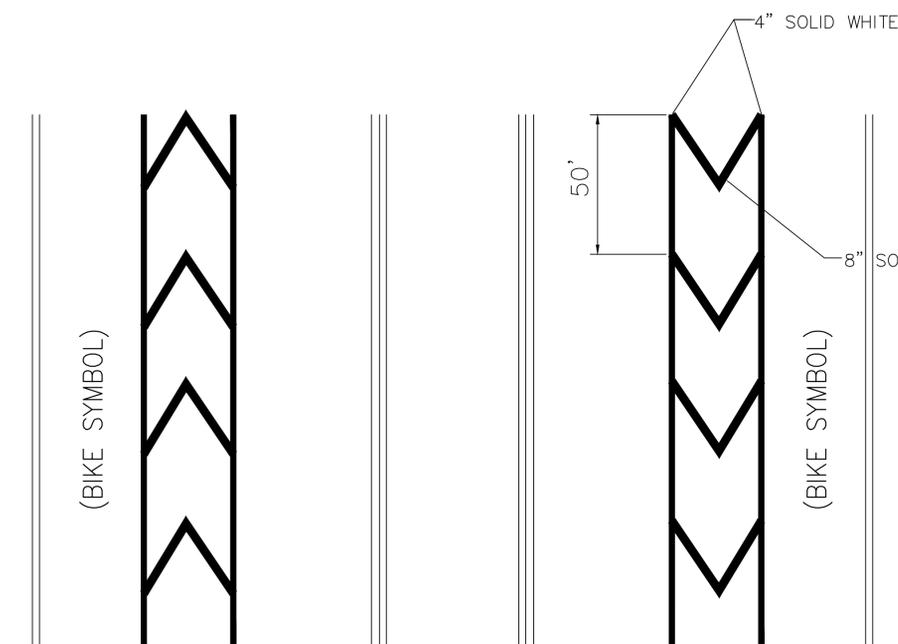
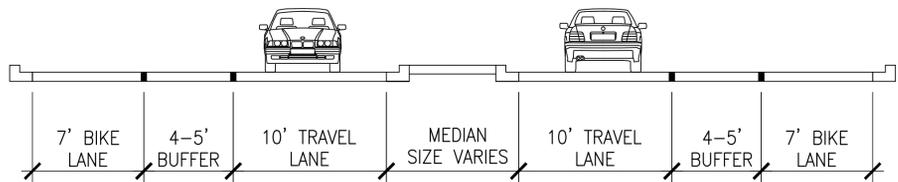
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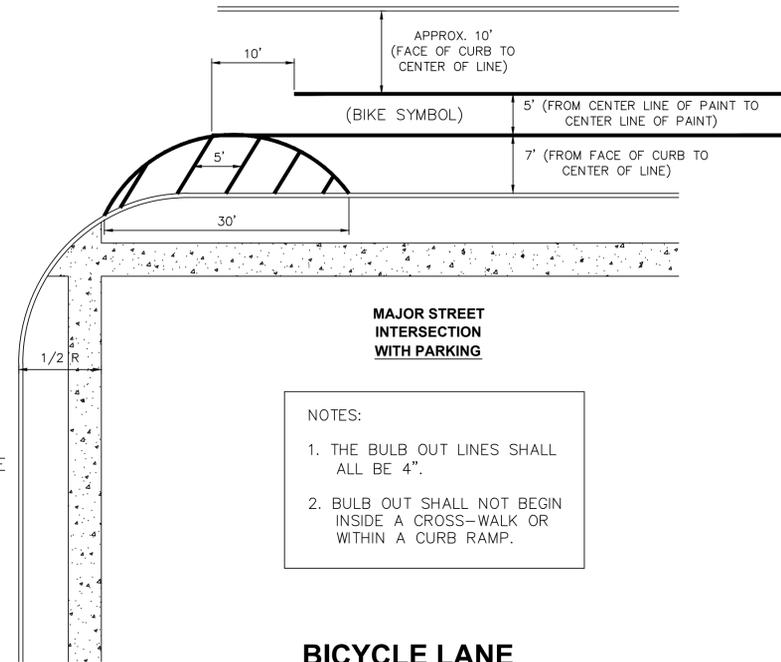
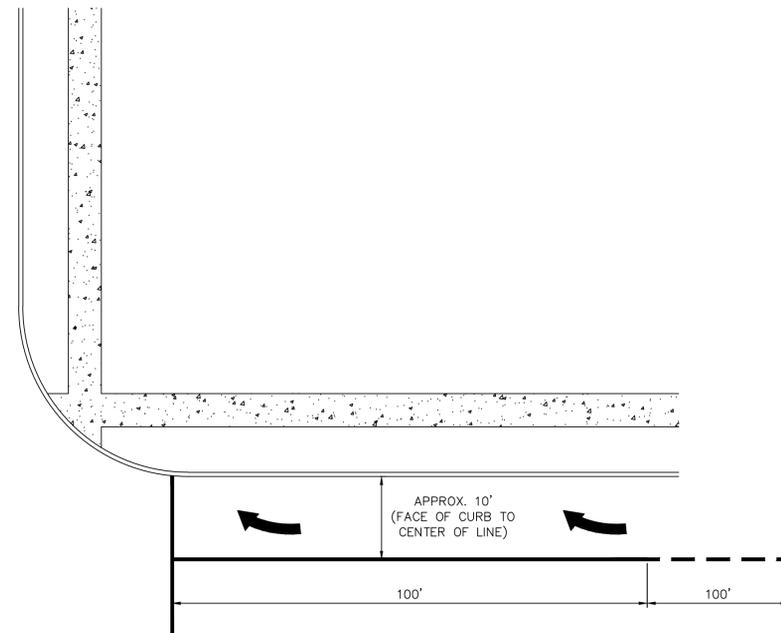
T-3



WITH PARKING



WITHOUT PARKING





MAJOR STREET INTERSECTION WITH PARKING

- NOTES:
1. THE BULB OUT LINES SHALL ALL BE 4".
 2. BULB OUT SHALL NOT BEGIN INSIDE A CROSS-WALK OR WITHIN A CURB RAMP.

BICYCLE LANE DETAIL (TYP) SURFACE MARKINGS

MATERIALS AS PER COR SPECIFICATIONS OR AS DIRECTED BY THE ENGINEER.

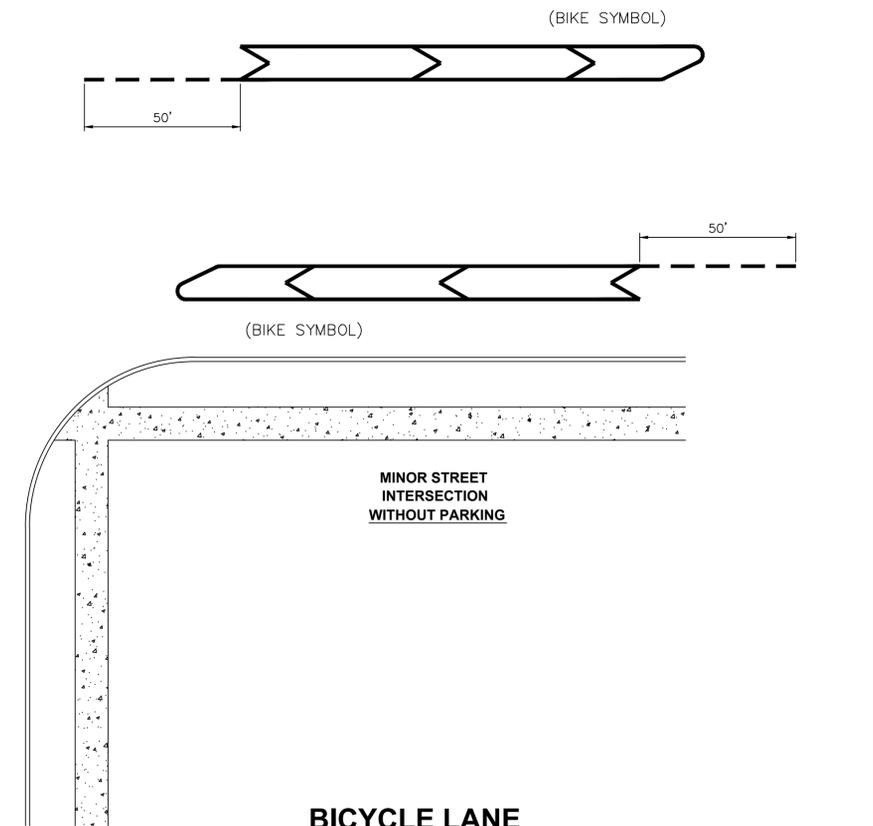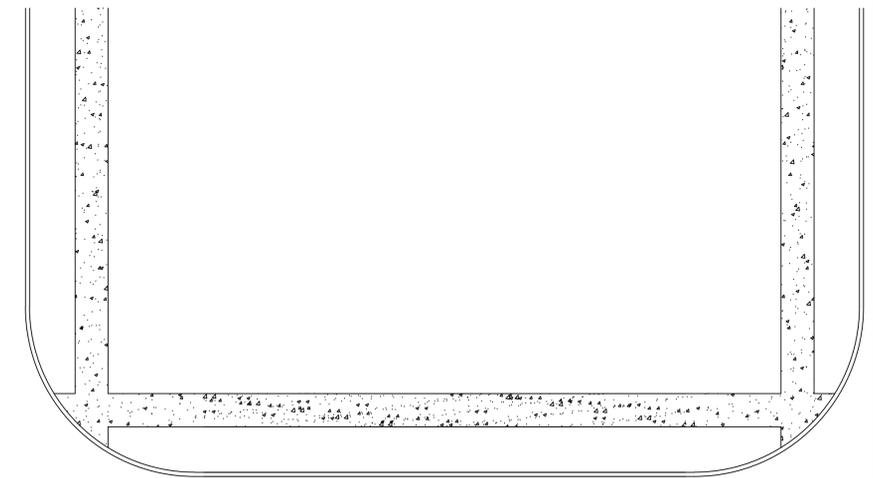

MINOR STREET INTERSECTION WITHOUT PARKING

BICYCLE LANE DETAIL (TYP) SURFACE MARKINGS

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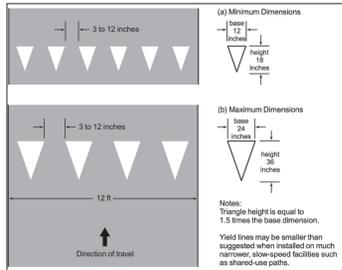
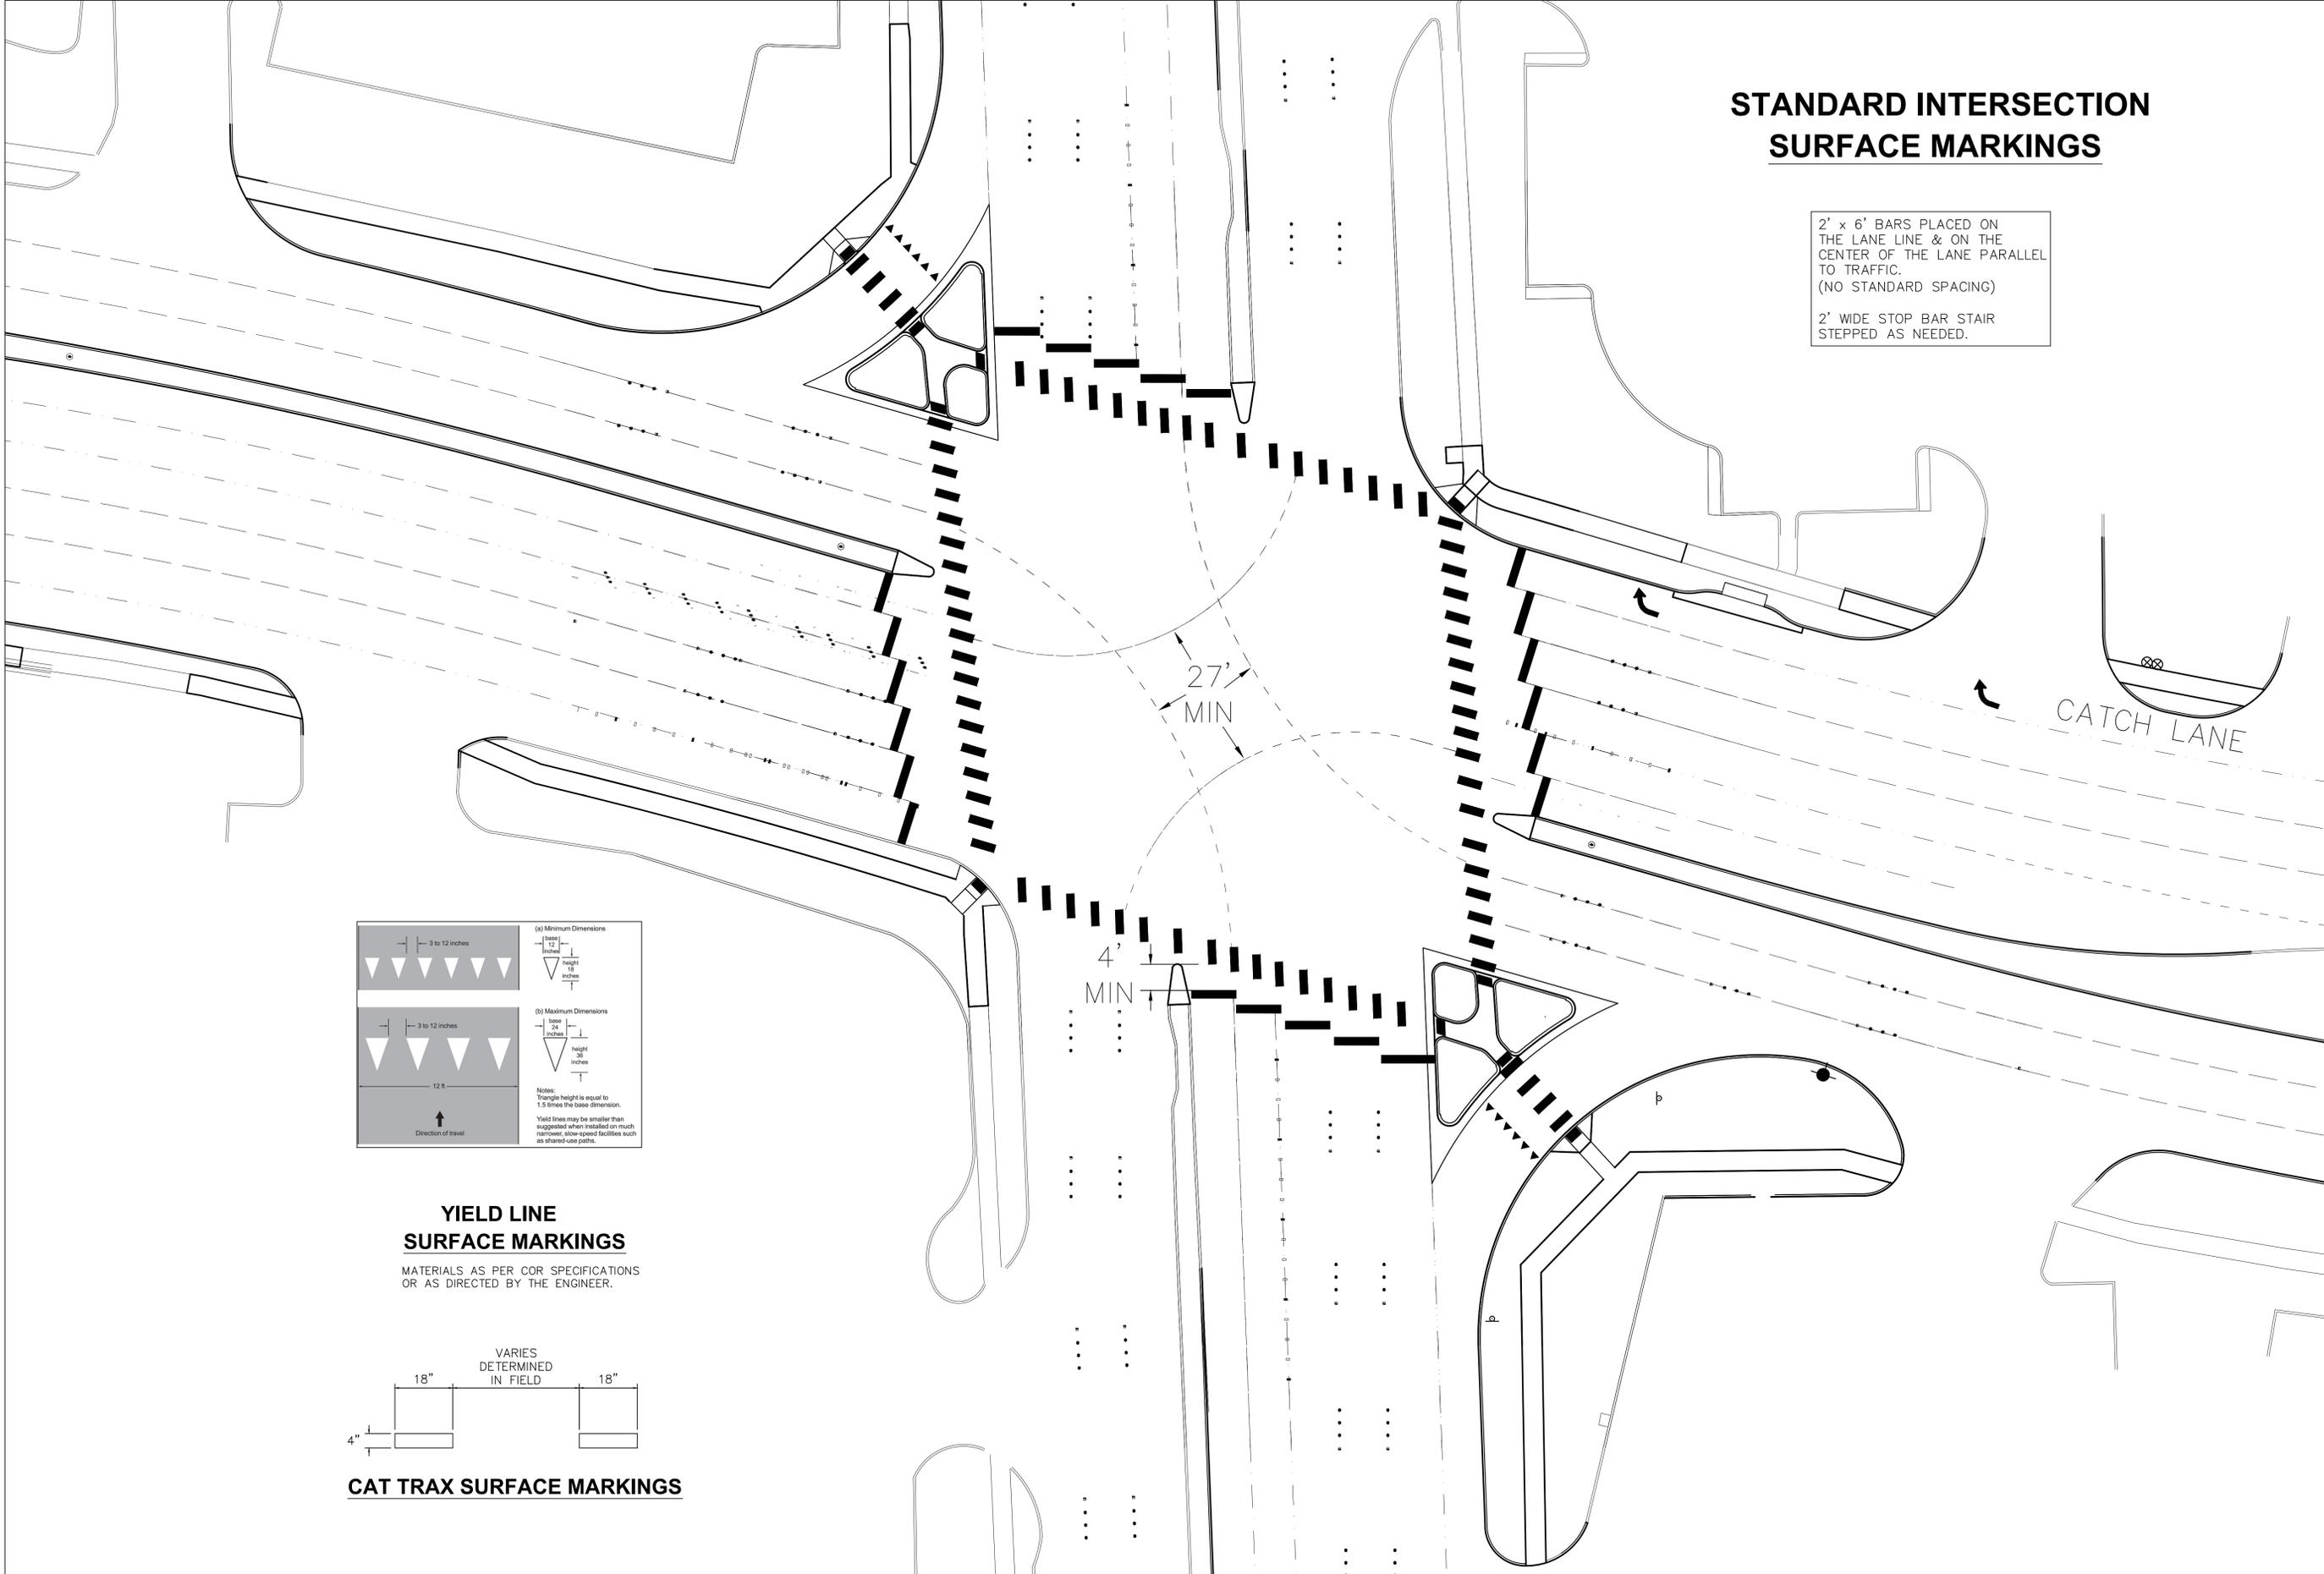
Sheet No.:

T-4

STANDARD INTERSECTION SURFACE MARKINGS


2' x 6' BARS PLACED ON THE LANE LINE & ON THE CENTER OF THE LANE PARALLEL TO TRAFFIC.
(NO STANDARD SPACING)

2' WIDE STOP BAR STAIR STEPPED AS NEEDED.



YIELD LINE SURFACE MARKINGS

MATERIALS AS PER COR SPECIFICATIONS OR AS DIRECTED BY THE ENGINEER.

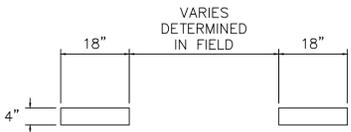

Revisions:

City of Richardson
411 W. Arapaho Road
Suite 204
Richardson, Texas 75080
voice: 972 744-4280
fax: 972 744-5804

Drawn By: RGB
Checked By: COR



STANDARD DETAILS

City of Richardson, Texas

NO ADDITIONS OR CHANGES TO STANDARD DETAIL SHEETS UNLESS APPROVED BY CITY OF RICHARDSON

24"x36" Scale: NTS
11"x17" Scale: NTS
Vertical Scale: NA
Project Number: XXX
Issue Date: 10 JUL 14
Sheet Title: **TRAFFIC**

Sheet No.: **T-5**